



REVISIONS				
SYM	DESCRIPTION	PREPARED BY	DATE	APPROVED

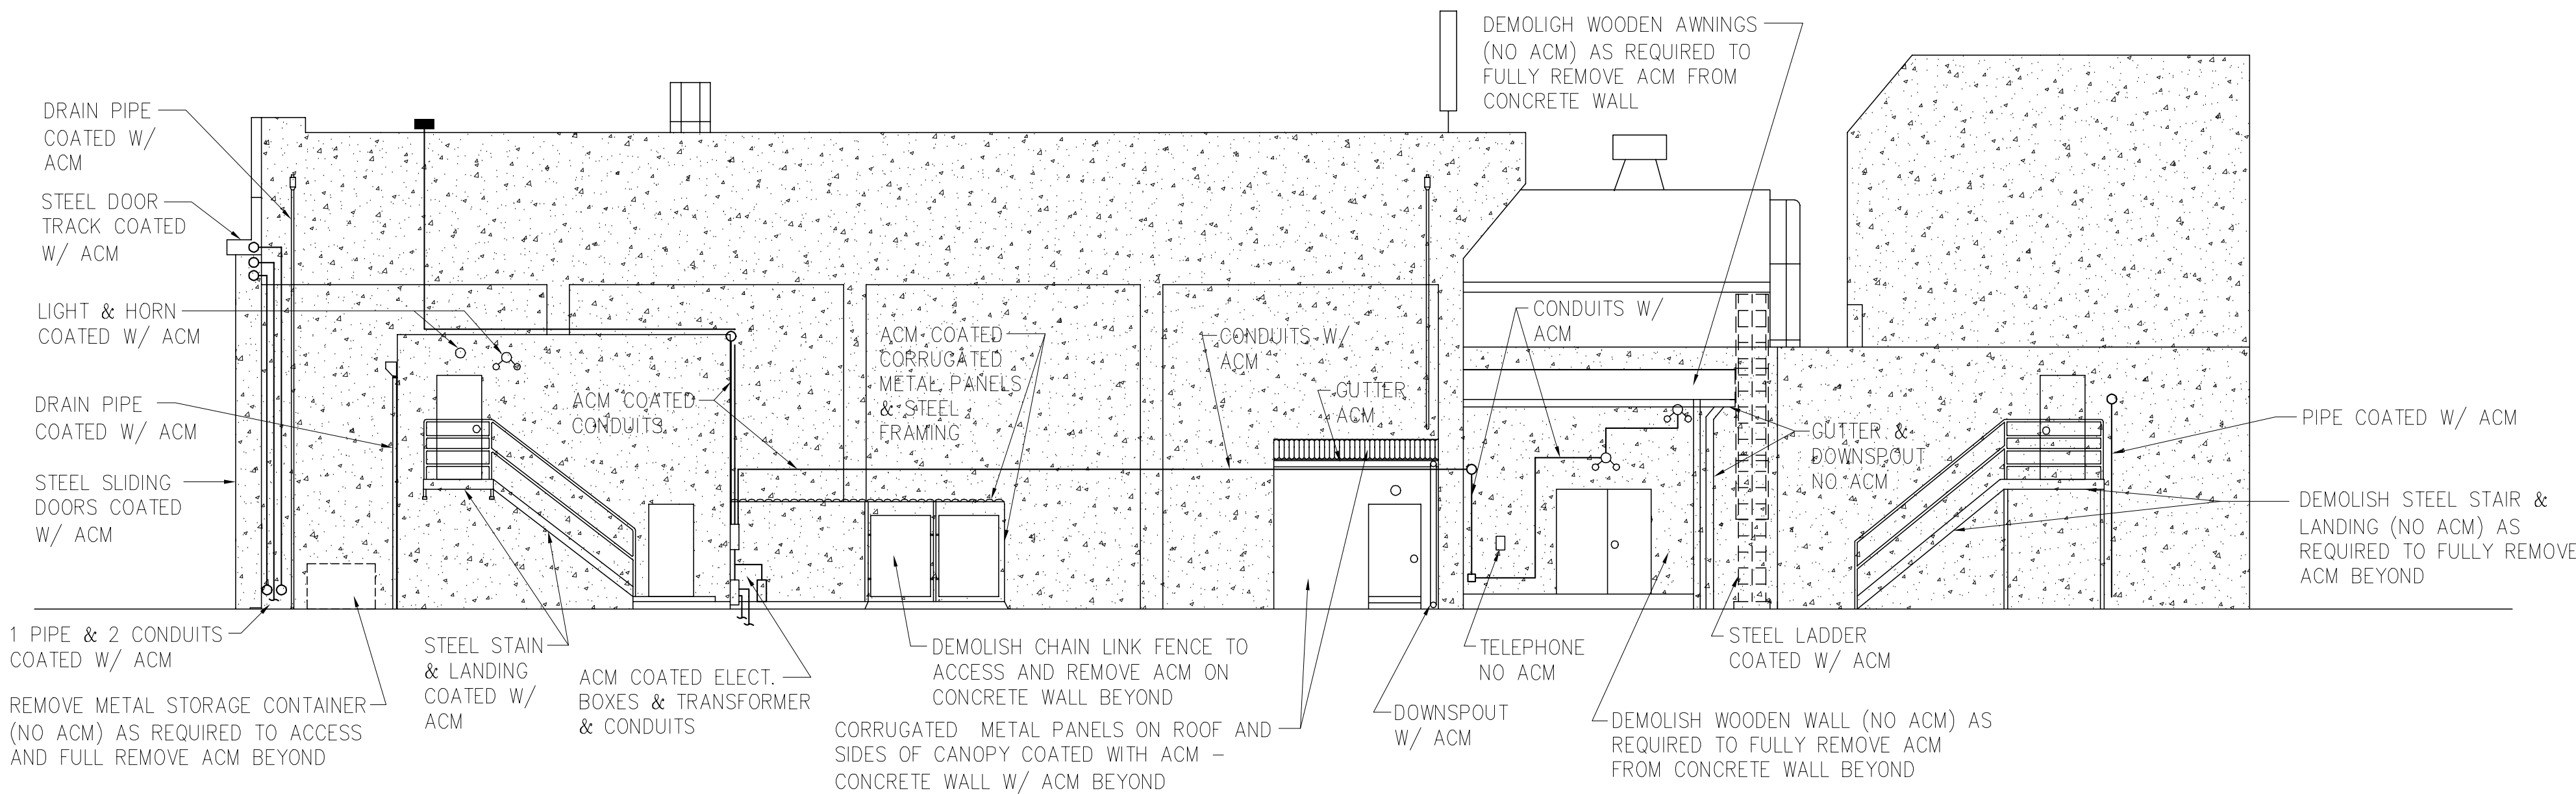


BUILDING 205 WEST ELEVATION

SCALE: 1:100

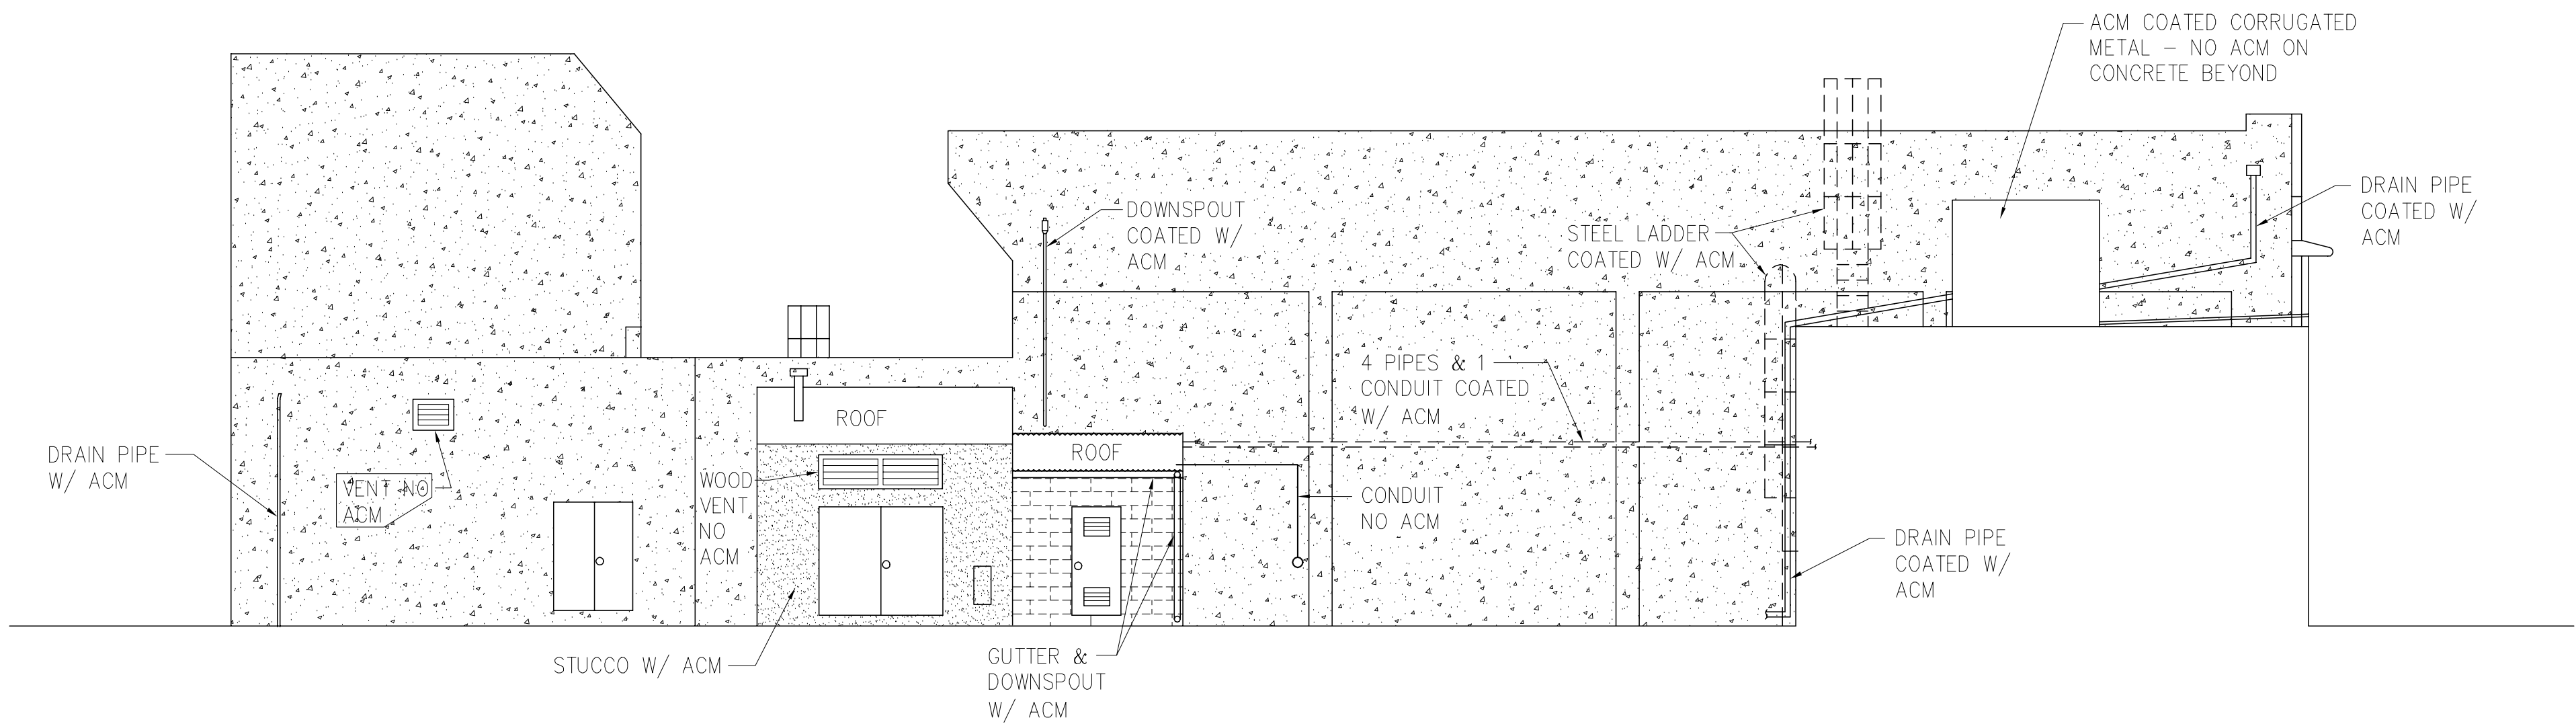

BUILDING 205 EAST ELEVATION - COURTYARD

SCALE: 1:100

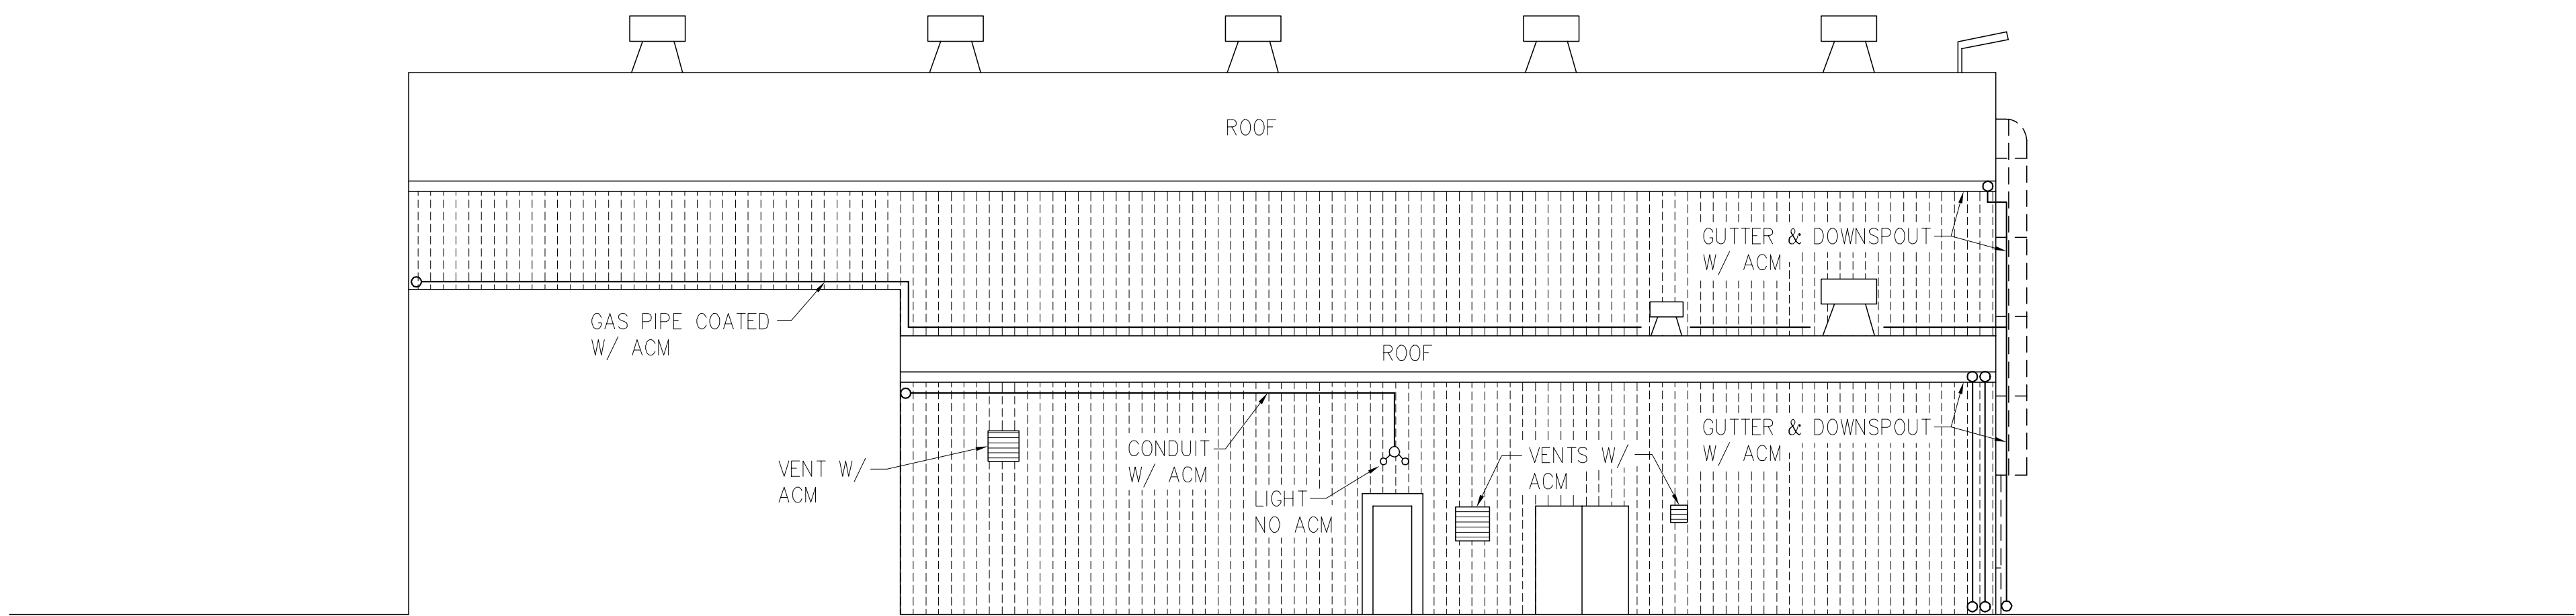

BUILDING 205 WEST ELEVATION - COURTYARD

SCALE: 1:100


HAZARDOUS MATERIAL ABATEMENT NOTES:

AC	ASBESTOS CONTAINING
ACM	ASBESTOS CONTAINING MATERIAL
LCP	LEAD CONTAINING PAINT
PCB	POLYCHLORINATED BIPHENYLS

- PRIOR TO ANY DEMOLITION ACTIVITIES AT BUILDINGS 200, 201, AND 205, THAT WOULD DISTURB HAZARDOUS MATERIALS, COMPLETELY REMOVE, UNLESS OTHERWISE INDICATED, ALL ACM, DETERIORATED LCP, PCB CONTAINING LIGHTING BALLAST, AND MERCURY CONTAINING LIGHTING LAMPS.
- ALL WORK ASSOCIATED WITH THE REMOVAL, HANDLING, TRANSPORT, AND DISPOSAL OF ACM SHALL BE CONDUCTED BY PROPERLY CERTIFIED INDIVIDUALS EMPLOYED BY PROPERLY LICENSED FIRMS UTILIZING THE EQUIPMENT AND METHODS AS INDICATED IN SPECIFICATION SECTION 13281.
- ALL WORK ASSOCIATED WITH THE DEMOLITION, HANDLING, TRANSPORT, AND DISPOSAL OF ITEMS COATED WITH LCP SHALL BE CONDUCTED BY PROPERLY TRAINED INDIVIDUALS UTILIZING APPROPRIATE PERSONAL PROTECTIVE EQUIPMENT AND METHODS AS INDICATED IN SPECIFICATION SECTION 13282.
- ALL WORK ASSOCIATED WITH THE REMOVAL, HANDLING, TRANSPORT, AND DISPOSAL OF DETERIORATED LCP SHALL BE CONDUCTED BY PROPERLY CERTIFIED INDIVIDUALS EMPLOYED BY PROPERLY LICENSED FIRMS UTILIZING THE EQUIPMENT AND METHODS AS INDICATED IN SPECIFICATION SECTION 13282.
- ALL WORK ASSOCIATED WITH THE REMOVAL, HANDLING, TRANSPORT, AND DISPOSAL OF PCB AND MERCURY CONTAINING LIGHTING COMPONENTS SHALL BE CONDUCTED BY PROPERLY TRAINED INDIVIDUALS UTILIZING THE EQUIPMENT AND METHODS AS INDICATED IN SPECIFICATION SECTION 13286.
- THE ACM REMOVAL WORK SHALL INCLUDE ALL DEMOLITION OR RELOCATION OF RUBBAGE, APPLIANCES, EQUIPMENT, CASEWORK, WALL FRAMING, OR OTHER NON-ACM MATERIALS COVERING OR CONNECTED TO THE ACM, AS REQUIRED TO FULLY ACCESS AND REMOVE THE ACM. THIS RELATED WORK SHALL BE PERFORMED WITHIN THE ESTABLISHED ASBESTOS CONTROL AREAS OR PRIOR TO ERECTION OF CONTAINMENTS PROVIDED THE DEMOLITION / RELOCATION WORK DOES NOT DISTURB ACM.
- ALL GYPSUM BOARD WITH AC JOINT COMPOUND INDICATED ON THESE DRAWINGS SHALL BE DEMOLISHED IN A MANNER THAT COMPLIES WITH CAL-OSHA REQUIREMENTS. THE AC CONTAINING GYPSUM WALL BOARD SYSTEMS DO NOT HAVE TO BE REMOVED AS ACM PRIOR TO BUILDING DEMOLITION.
- AC MASTIC MAY BE LEFT ON THE FLOOR SUBSTRATE; HOWEVER, THE SUBSTRATE MATERIAL SHALL NOT BE RECYCLED.
- ALL DEMOLITION WASTE WHICH CONTAINS ACM THAT IS ALLOWED, BY THIS CONTRACT AND APPLICABLE REGULATIONS, TO REMAIN IN THE BUILDING DURING DEMOLITION SHALL BE DISPOSED OF IN A PROPERLY PERMITTED LANDFILL AND SHALL NOT BE RECYCLED.
- ALL DISPOSAL OF CONSTRUCTION AND DEMOLITION DEBRIS, EXCEPT AS OTHERWISE INDICATED, SHALL BE IN ACCORDANCE WITH CONSTRUCTION AND DEMOLITION DEBRIS RECYCLING REQUIREMENTS SPECIFIED IN DIVISION 01 OF THE CONTRACT DOCUMENTS.

LEGEND


AC = ASBESTOS CONTAINING
ACM = ASBESTOS CONTAINING MATERIAL
LCP = LEAD CONTAINING PAINT
CMU = CONCRETE MASONRY UNIT

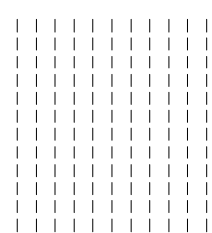


CORRUGATED METAL SIDING COATED WITH LCP AND SPRAY APPLIED AC TREATMENT




CONCRETE COATED WITH LCP AND SPRAY APPLIED AC TREATMENT

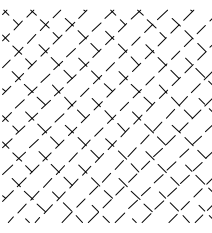


SMOOTH METAL PANEL AT BASE OF NON-OPERABLE SLIDING HANGAR DOOR COATED WITH LCP AND SPRAY APPLIED AC TREATMENT

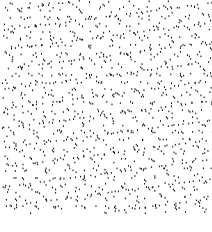

METAL FRAMED CONCRETE FILLED NON-OPERABLE SLIDING HANGAR DOOR COATED WITH LCP AND SPRAY APPLIED AC TREATMENT

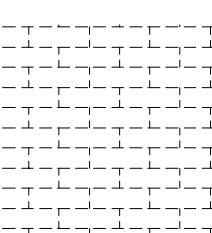

CMU COATED WITH LCP AND SPRAY APPLIED AC TREATMENT

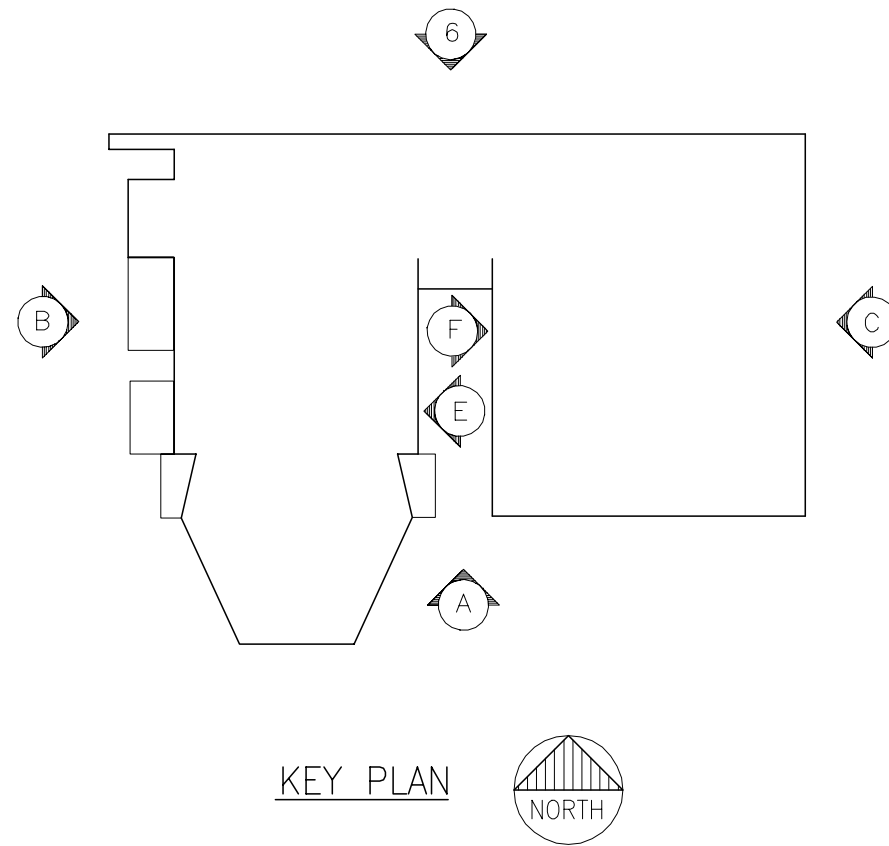

KEY PLAN



IF SHEET IS LESS THAN 28"x42", IT IS A REDUCED PRINT. SCALE REDUCED ACCORDINGLY.

HM-8

MEDICAL/DENTAL CLINIC

HAZARDOUS MATERIAL REMOVAL
BUILDING 205 EXTERIOR ELEVATIONS

SIZE	CODE	IDENT. NO.	DRAWING NO.
F	XXXXX		8144547
SCALE:	AS SHOWN	SPEC.	11996048
		SHEET	42 OF 316