

# BUILDING INFORMATION MODEL

# COMMON FILE

# BARRACKS 101

NATIONAL INSTITUTE OF BUILDING SCIENCES

buildingSMART alliance

WASHINGTON, DC



National Institute of Building Sciences

Building Smart Alliance

Washington, DC



**Barracks 101**

**Building Information Model  
Common File**

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**COVER SHEET  
G001**




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### Barracks 101
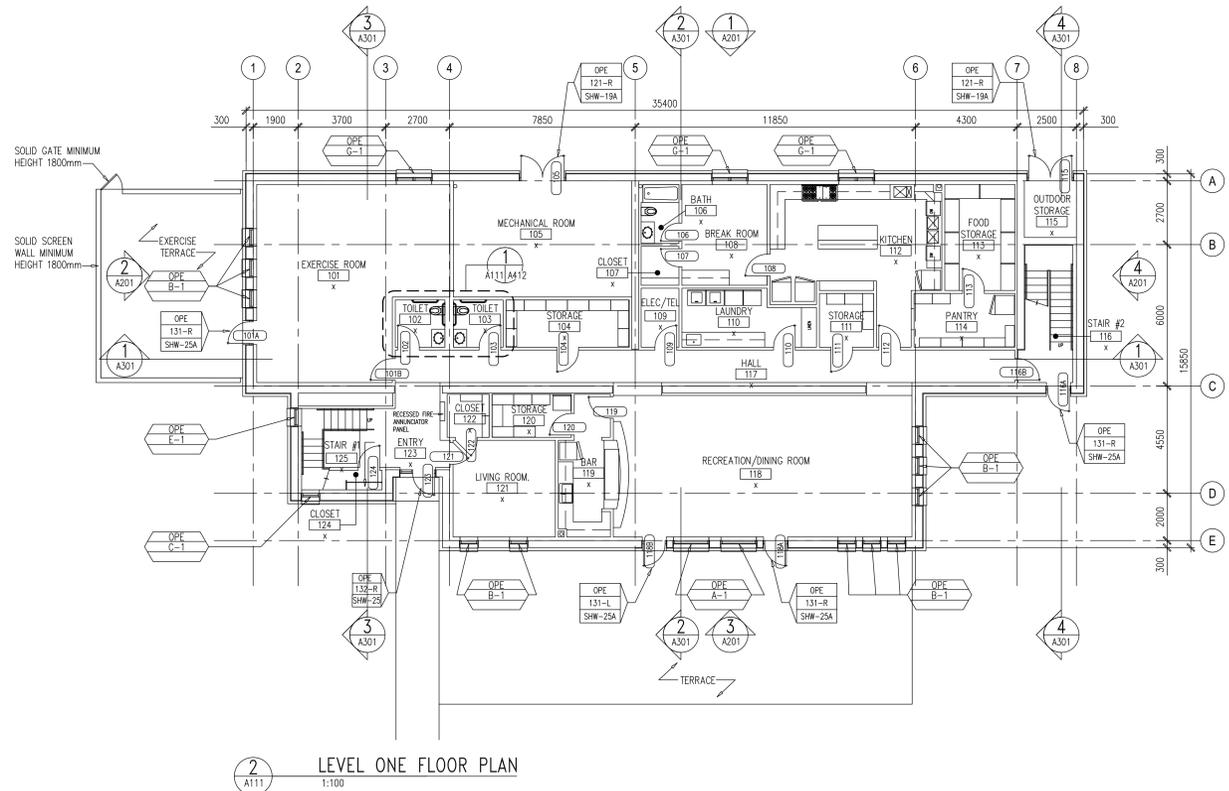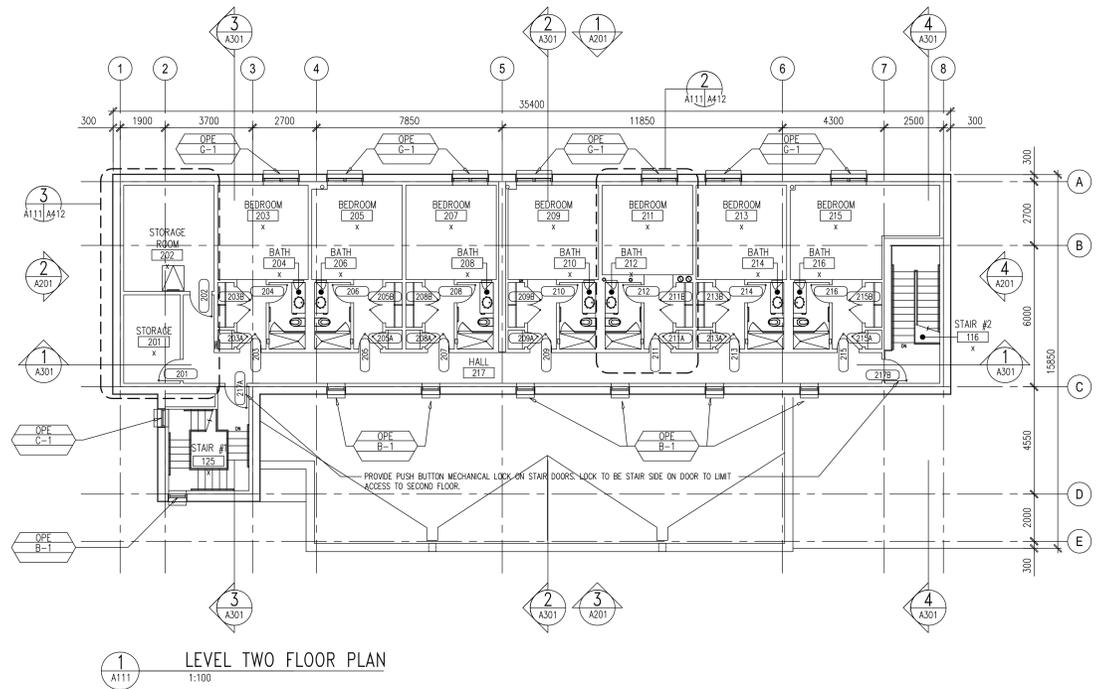
#### Building Information Model Common File

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#### LEGEND



NOTE:  
HEAVY DUTY METAL SHELVING IN ALL STORAGE ROOMS (CFL).

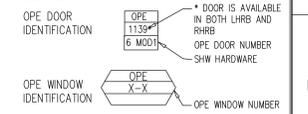
Rev. Number	Description	Date
Revisions		

Release For Construction: NBS/bsa


Drawing Title: **FLOOR PLANS**

DBO Project Number: 101  
Phase: NOTED  
CAO File Name: CBMA111.DWG  
CAO Plot Scale: 1:1


Date: NOV-2012  
Sheet Number: 101  
Drawn By: NIBS/bsa  
Checked By: NIBS/bsa  
Project Number: Barracks 101  
Classification: UNCLASSIFIED

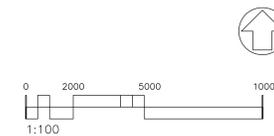

ALL DIMENSIONS WITHOUT A DECIMAL ARE IN MILLIMETERS UNO. ALL DIMENSIONS WITH A DECIMAL ARE IN METERS UNO.

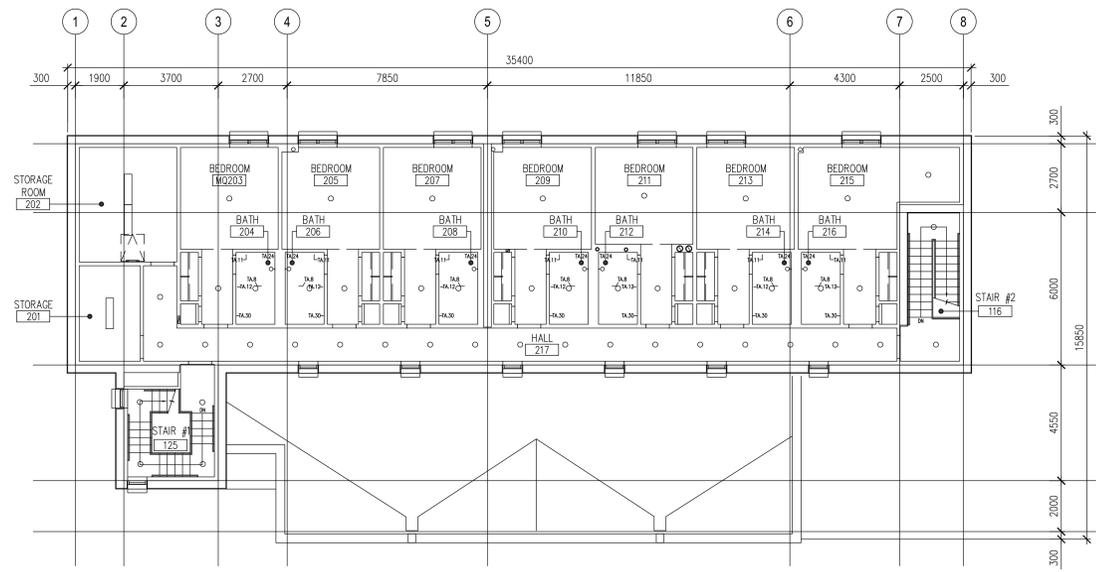

1 LEVEL TWO REFLECTED CEILING PLAN  
A112 1:100

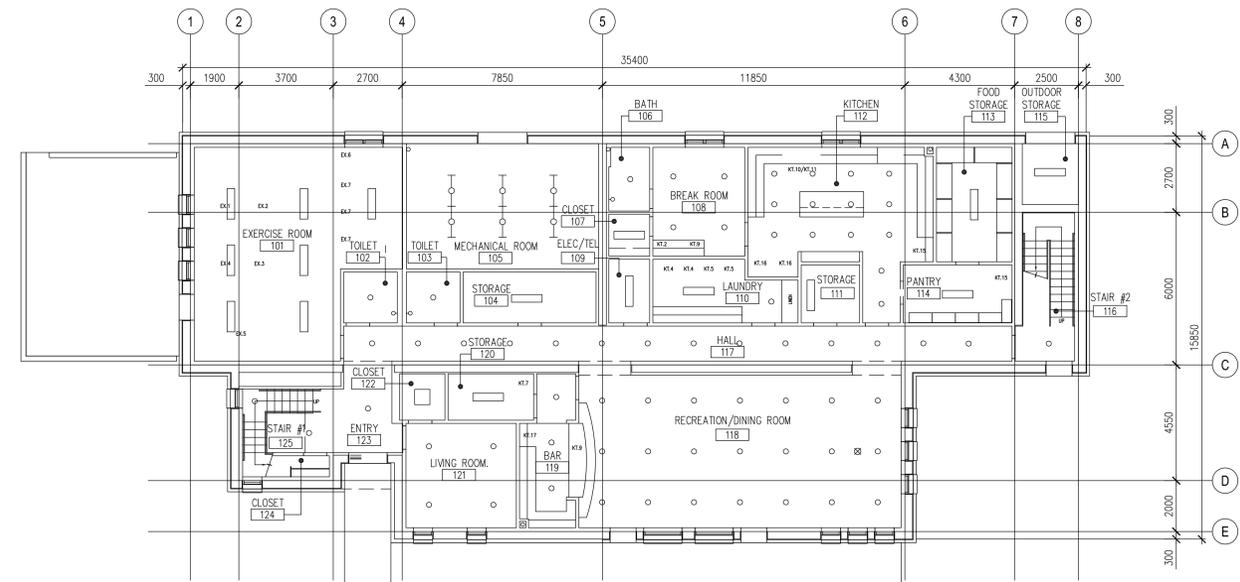

2 LEVEL ONE REFLECTED CEILING PLAN  
A112 1:100


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Building Information Model  
Common File


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Rev. Number	Description	Date
Revisions		

Release For Construction:		NIBS/As
Drawing Title		
<b>REFLECTED CEILING PLANS</b>		
DBO Project Number	Drawing Scale	Phase
AS NOTED	1:1	CONCEPT
CAD File Name	CAD Plot Scale	DATE
CBMA112.DWG	1:1	NOV-2012
Drawn By	Checked By	Project Number
NIBS	NIBS	Barracks A112
Classification		
UNCLASSIFIED		



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1 ROOF PLAN  
A121  
1:100
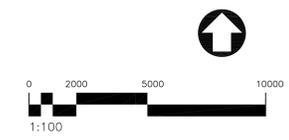
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**SITE SPECIFIC DESIGN NOTES:**

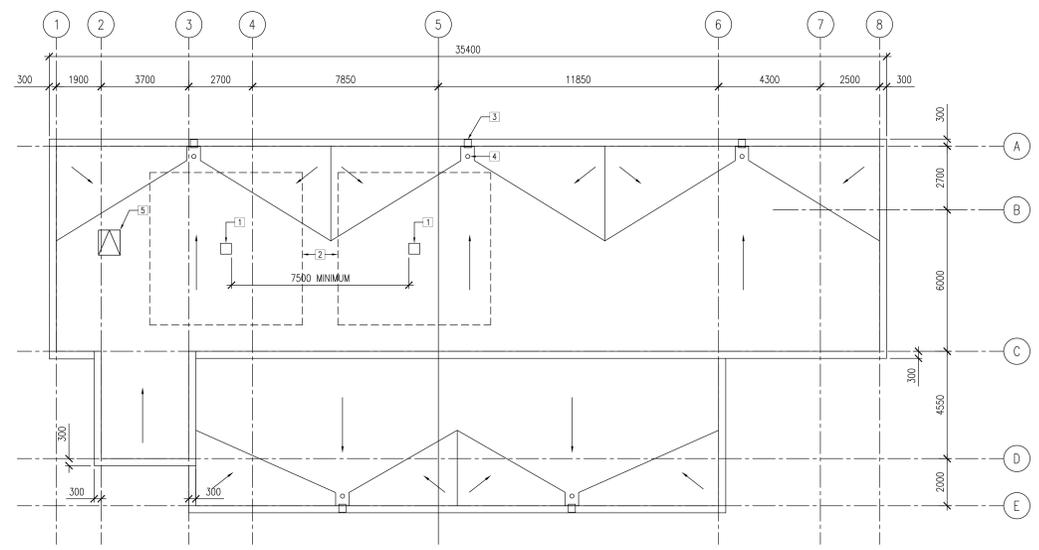- SCUPPER AND ROOF DRAINS INDICATED SHALL BE CONSIDERED SITE SPECIFIC MINIMUMS.

**KEYNOTES:**

- VHF / UHF ANTENNA PADS MINIMUM 460mm X 460mm WITH GALVANIZED J-BOLTS (4 PER PAD) WITH MINIMUM 25.4mm CONDUIT RUNS TO EMERGENCY RESIDENTIAL RESPONSE ROOM.
- MINIMUM CLEAR ZONE FOR ANTENNA GUY LINE ANCHORS
- OVER FLOW SCUPPER TYP. SEE DETAIL 2/GEN A541
- ROOF DRAIN TYP. SEE DETAIL 4/GEN A541
- ROOF HATCH


Rev Number	Description	Date
Revisions		

Release For Construction:  
NIBS/Asa NIBS/Asa

Drawing Title  
**ROOF PLAN**

DBO Project Number	Drawing Scale	Phase
AS NOTED	1:100	CONCEPT
CAD File Name	CAD Plot Scale	1:1
CBMA121.DWG		

Date	NOV-2012	Sheet Number
Drawn By	NIBS	<b>Barracks</b> <b>A121</b>
Checked By	NIBS	
Project Number		
Classification	UNCLASSIFIED	

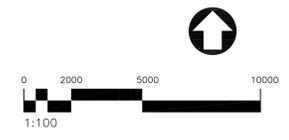

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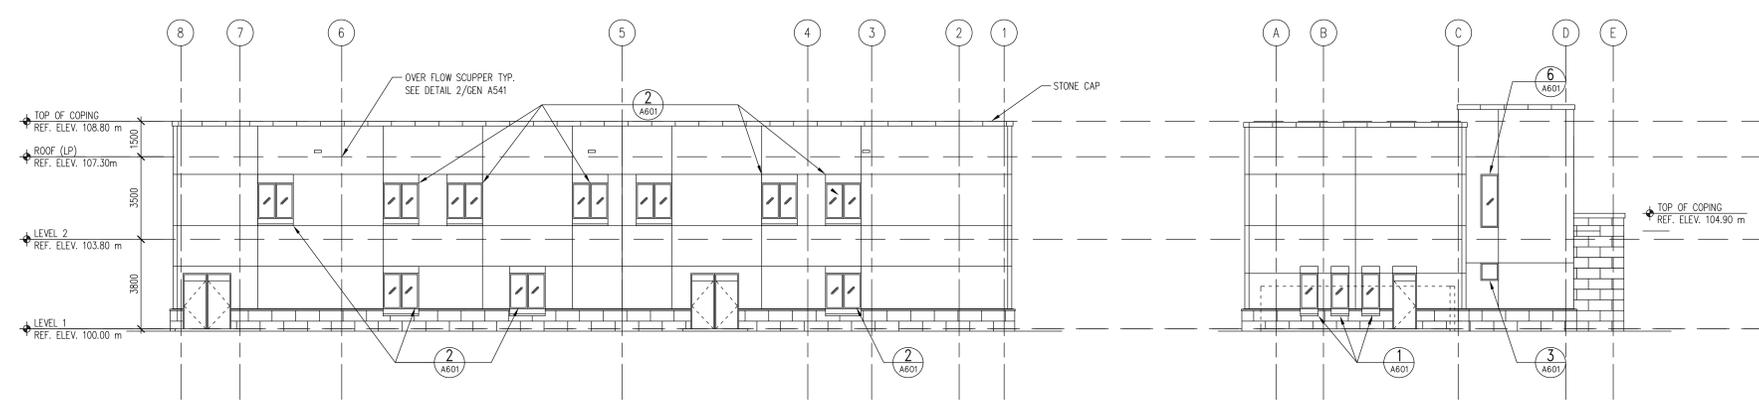
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Building Information Model  
Common File


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GENERAL NOTES:  
1. PROVIDE SITE SPECIFIC DESIGN FOR WINDOW SHADING DEVICES.




**1 NORTH ELEVATION**  
A111/A201 1:100

**2 WEST ELEVATION**  
A111/A201 1:100

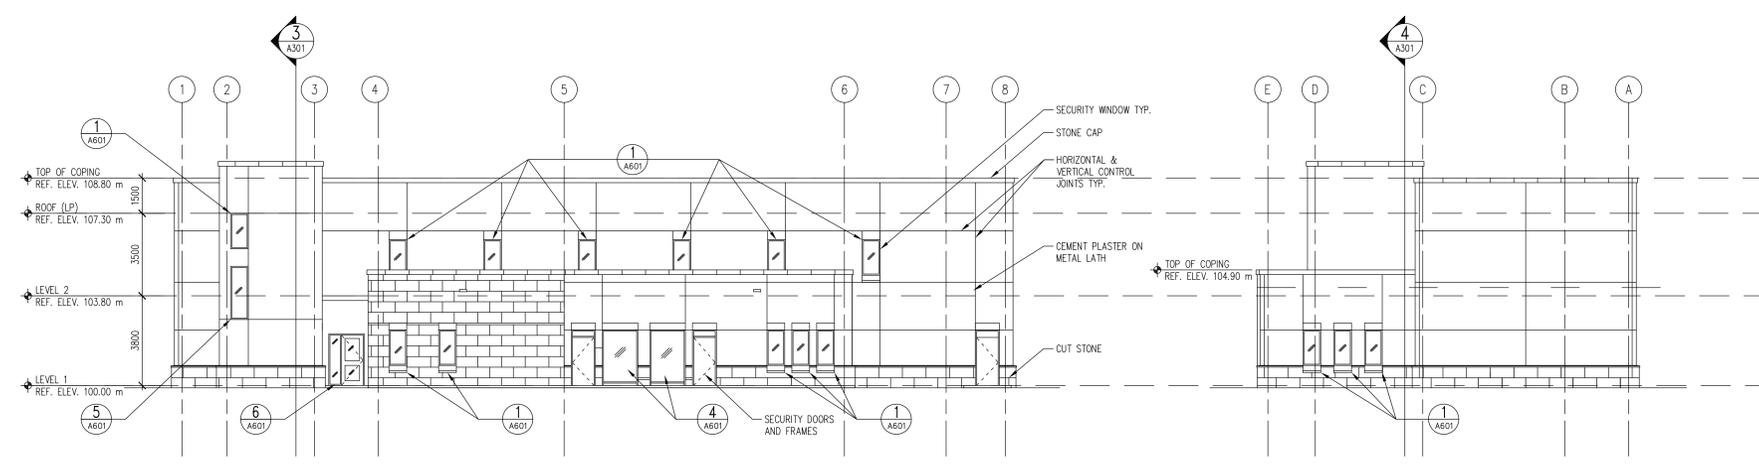

**3 SOUTH ELEVATION**  
A111/A201 1:100

**4 EAST ELEVATION**  
A111/A201 1:100

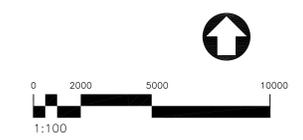

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Rev. Number	Description	Date
Revisions		

Release For Construction:		NIBS/Asa	
Drawing Title			
<b>BUILDING ELEVATIONS</b>			
GEO Project Number	Drawing Scale	Phase	AS NOTED 50%
GEO File Name	GEO Plot Scale	CONCEPT	1:1
CBMA201.DWG	1:1		
Date	NOV-2012	Sheet Number	
Drawn By	NIBS	<b>Barracks</b>	
Checked By	NIBS	<b>A201</b>	
Project Number			
Classification	UNCLASSIFIED		

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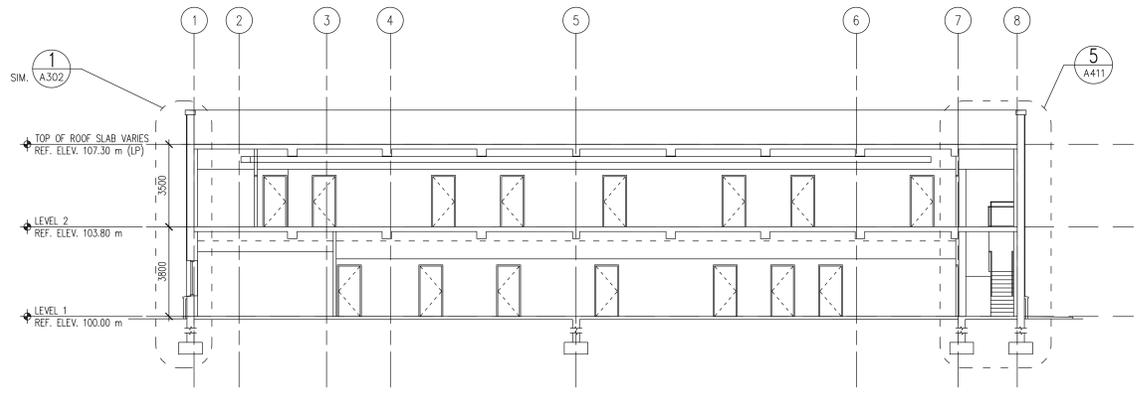
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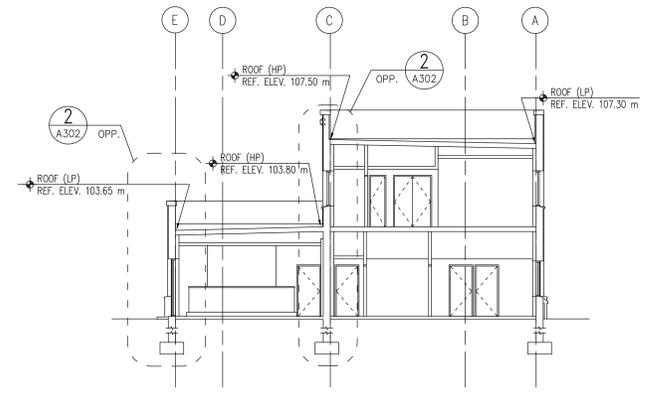
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Building Information Model  
Common File


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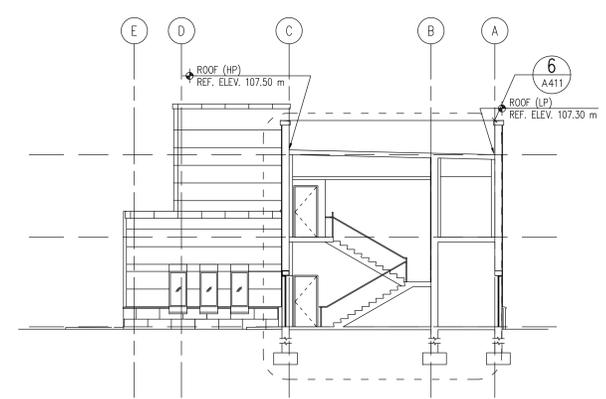
**1 BUILDING SECTION**  
A111/A301 1:100



**2 BUILDING SECTION**  
A111/A301 1:100



**3 STAIR SECTION**  
A111/A301 1:100

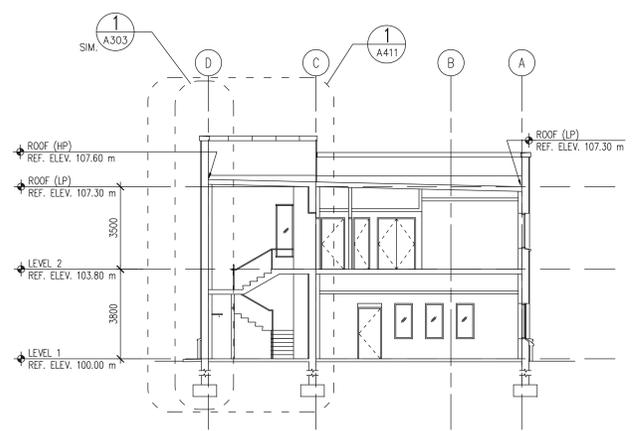

**4 STAIR SECTION**  
A111/A301 1:100



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Rev. Number	Description	Date
Revisions		

Release For Construction: NIB/Asa

**BUILDING SECTIONS**

IBO Project Number	Drawing Scale	Phase
AS NOTED	1:1	100%
CAD File Name	CAD Plot Scale	DATE
CBMA301.DWG	1:1	NOV -2012
Project Number	Sheet Number	
	Barracks	
	A301	
Classification	UNCLASSIFIED	

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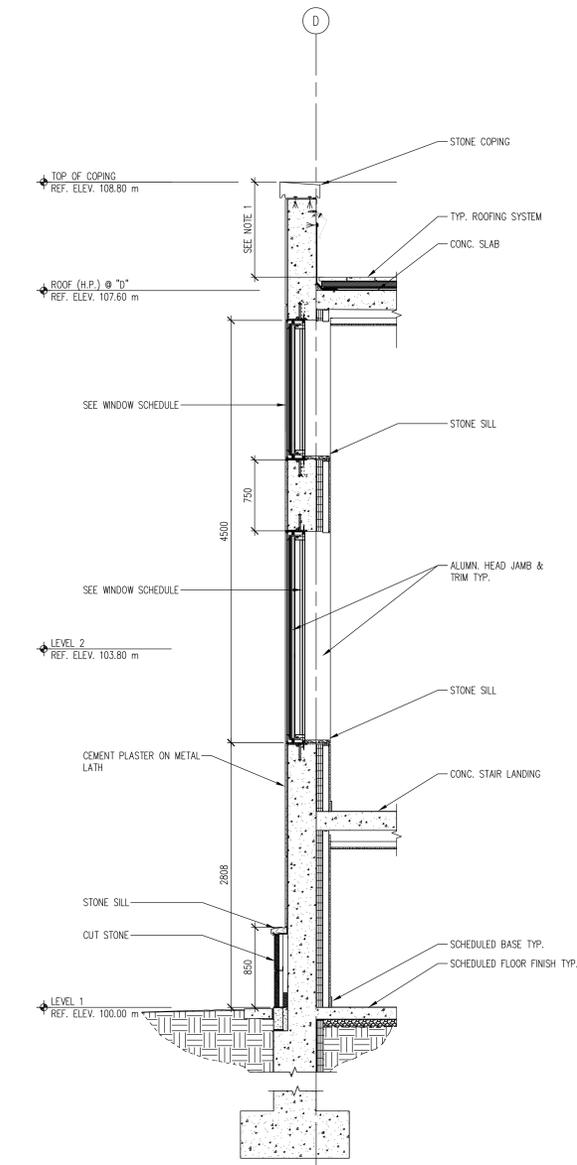
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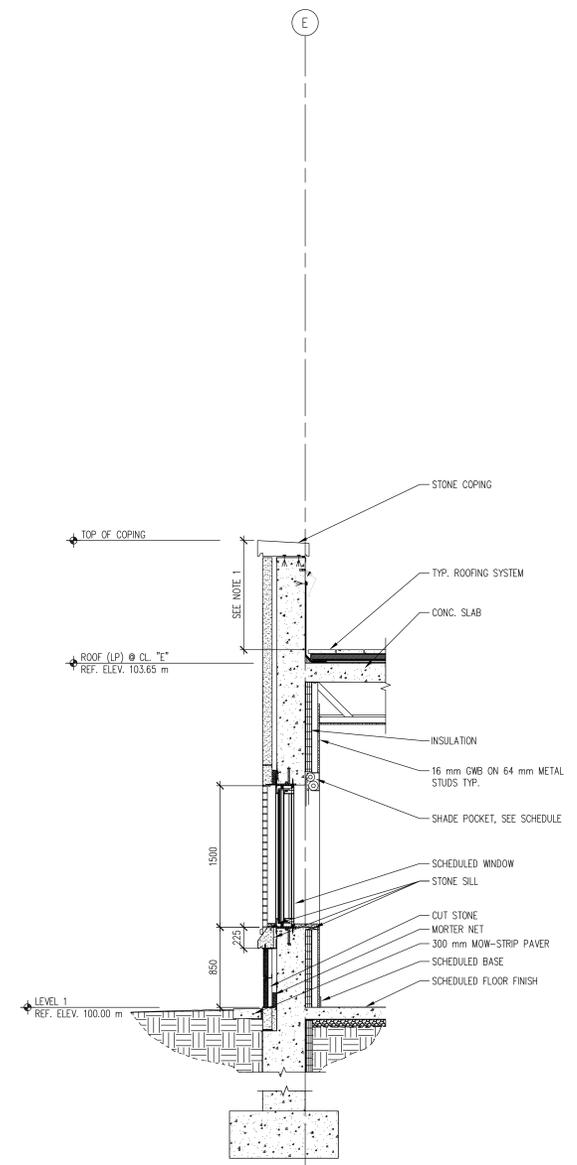
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**SITE SPECIFIC DESIGN CRITERIA:**  
1. PARAPET HEIGHT SHALL BE MINIMUM 1080 mm AS MEASURED FROM ABOVE THE ADJACENT WALKING SURFACE TO THE TOP OF COPING, UNLESS NOTED OTHERWISE.



**1 WALL SECTION @ STAIR**  
A301/A303 1:25



**2 WALL SECTION**  
A301/A303 1:25



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Rev. Number	Description	Date
Revisions		

Release For Construction: NIB/Asa

**WALL SECTIONS**

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Drawing Scale: 1:25  
CAD File Name: CBMA303.DWG  
CAD Plot Scale: 1:1








Date: NOV-2012	Sheet Number:
Drawn By: NIBS	<b>Barracks A303</b>
Checked By: NIBS	
Project Number:	Classification: UNCLASSIFIED

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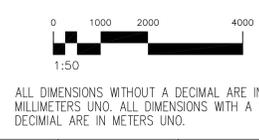
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Rev. Number	Description	Date
Revisions		

Release For Construction:		NIBS/Asa	
Drawing Title			
<b>ENLARGED STAIR PLANS AND SECTIONS</b>			
DBO Project Number	Drawing Scale	Phase	
AS NOTED	1:50	100%	
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CBMA411.DWG	1:1		
Date	NOV-2012	Sheet Number	
Drawn By	NIBS	<b>Barracks A411</b>	
Checked By	NIBS		
Project Number		Classification	
		UNCLASSIFIED	



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**FUNCTIONAL REQUIREMENTS FOR EMERGENCY RESPONSE ROOM**

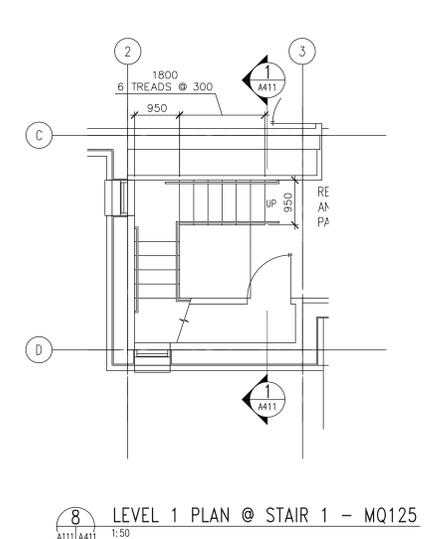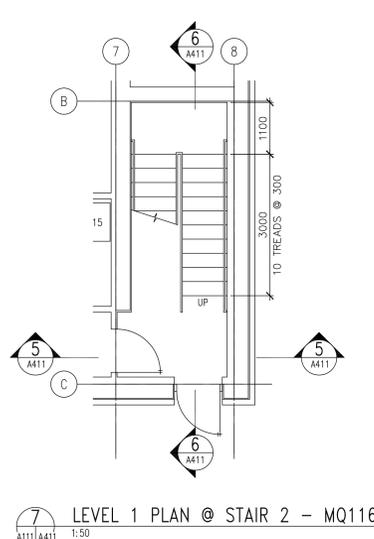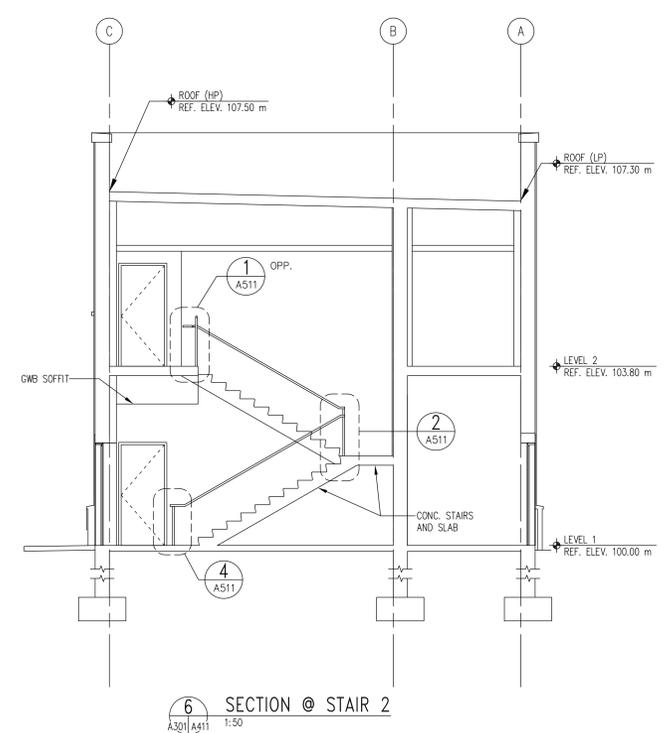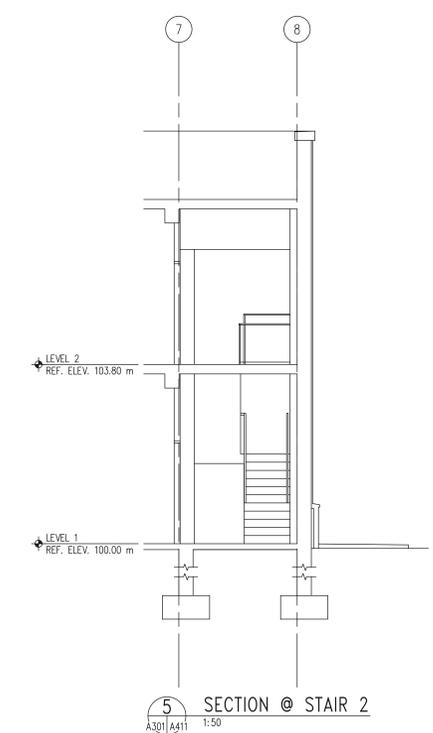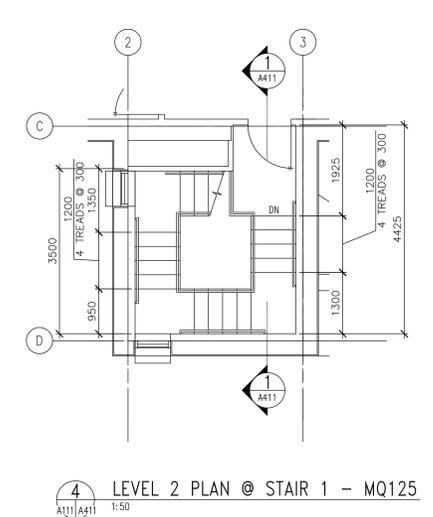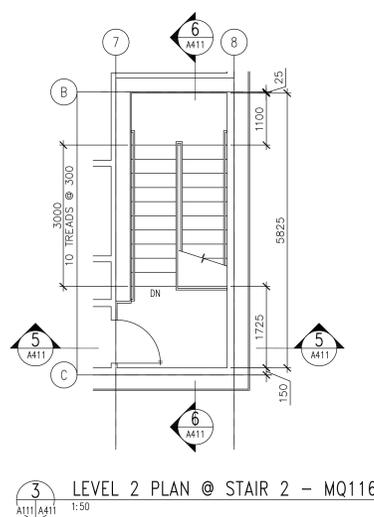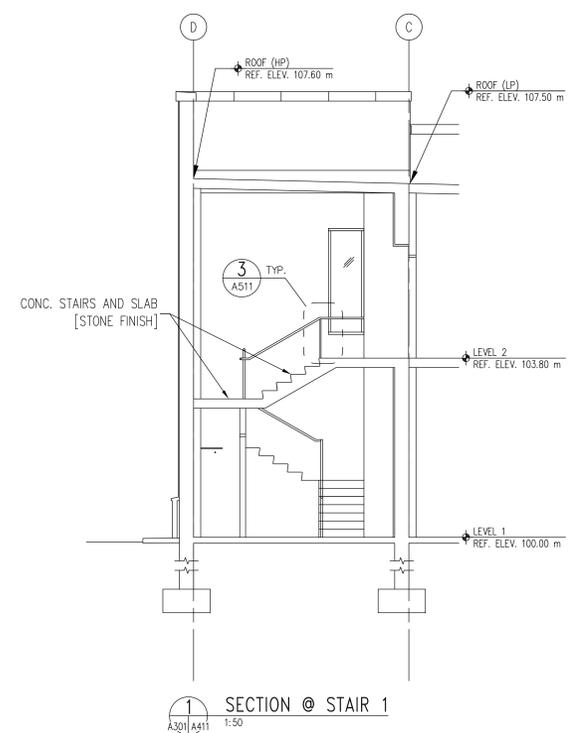**CONTRACTOR FURNISHED / CONTRACTOR INSTALLED**


- DIVISION 05 - METALS**  
 #05500 METAL FABRICATIONS - REFER TO NOB A404.  
 7 REACT EQUIPMENT RACKS
- DIVISION 10 - SPECIALTIES**  
 #10505 LOCKERS  
 1 HAZ-MAT LOCKER  
 NOMINAL DIMENSION 595mm X 500mm \*23.5"x20"  
 HEIGHT MAY VARY, NTE 1524mm (60")
- #10801 TOILET & BATH ACCESSORIES  
 1 MIRROR, FULL LENGTH, WALL-MOUNTED @ 1829mm (72") A.F.F.
- DIVISION 12 - FURNISHINGS**  
 #12460 FURNISHING ACCESSORIES  
 1 CLOCK, BATTERY OPERATED
- DIVISION 26 - ELECTRICAL AND 27 - COMMUNICATIONS**  
 SEE DIVISION 16 ELECTRICAL  
 1 DUPLEX OUTLETS, 1067mm (42") A.F.F. @ ENTRY  
 1 TELECOM OUTLET, 1067mm (42") A.F.F. @ ENTRY

**OWNER FURNISHED / OWNER INSTALLED - POST PROVIDED.**


- 7 RSO MAP / PLAN SAFE, 5 DRAWER  
 8 STORAGE SAFE  
 9 SAFETY EQUIPMENT STORAGE  
 10 SAFE CABINET

**OWNER FURNISHED / CONTRACTOR INSTALLED**

- 11 STORAGE CABINET, SUBDIVIDED  
 914mm X 457mm (36"x18")  
 HEIGHT MAY VARY, NTE 1626mm (64")

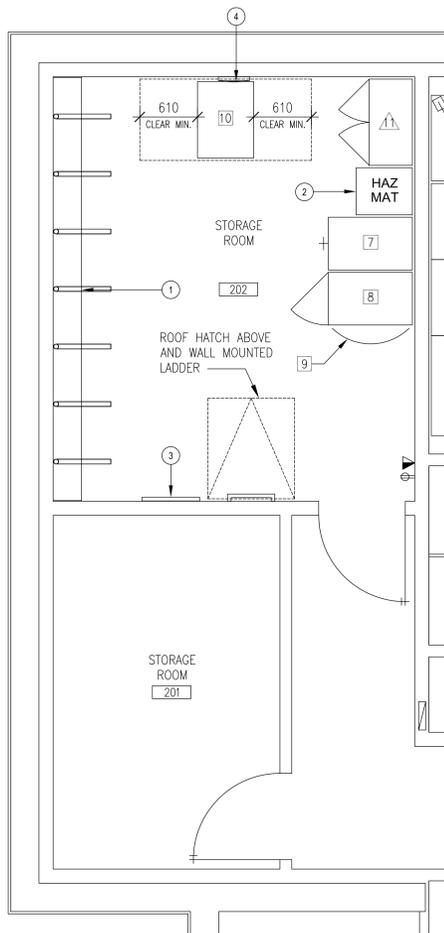


**3** ENLARGED PLAN AT EMERGENCY RESIDENTIAL RESPONSE ROOM  
 A412 1:25

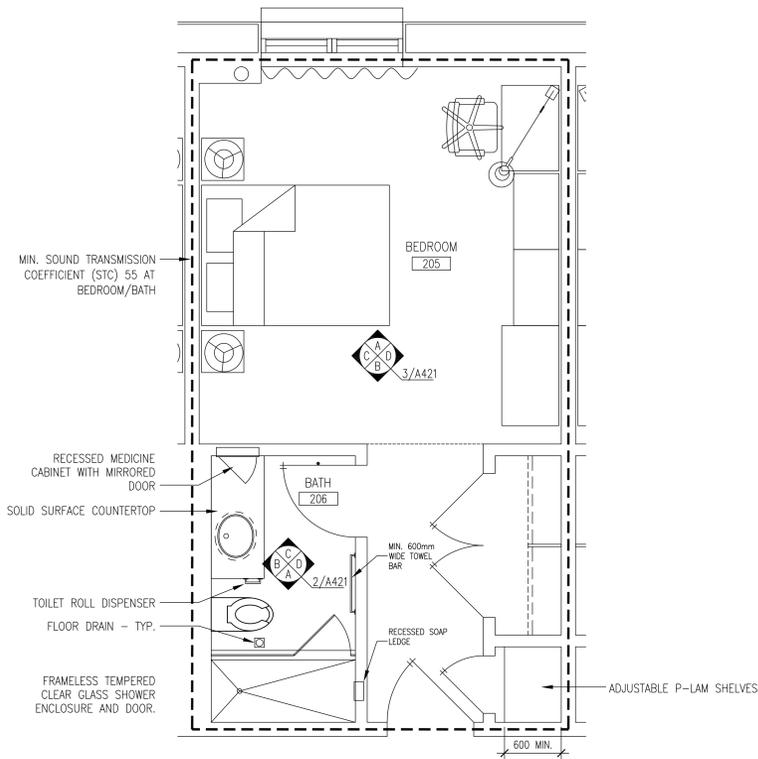

NOTE: TYPICAL FURNITURE LAYOUT. SEE FURNITURE PLANS FF1.11. FURNITURE N.I.C.

**2** ENLARGED PLAN AT TYPICAL BEDROOM  
 A412 1:25

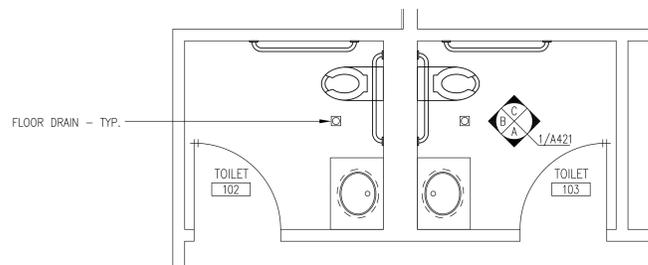

**1** ENLARGED PLAN AT TOILETS  
 A412 1:25

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Revisions		

Release For Construction:  
 NIBS/As NIBS/As

**ENLARGED FLOOR PLANS**

DBO Project Number Drawing Scale Phase  
 AS NOTED 04/11  
 CAD File Name CAD Plot Scale  CONCEPT  IIR  IIR  IIR  IIR  
 CBMA412.DWG 1:1


Date NOV-2012 Sheet Number  
 Drawn By NIBS Barracks  
 Checked By NIBS A412  
 Project Number  
 Classification UNCLASSIFIED




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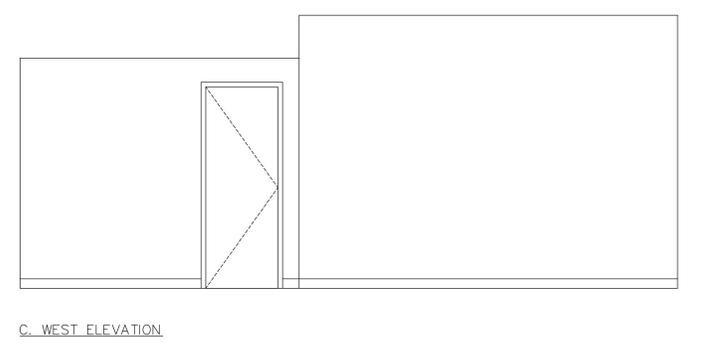
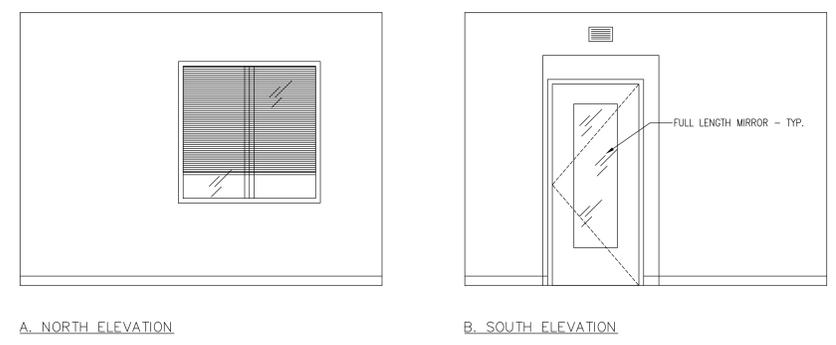
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1 MQ-103 - ELEVATIONS  
A412/A421 1:25



2 MQ-206 - ELEVATIONS  
A412/A421 1:25

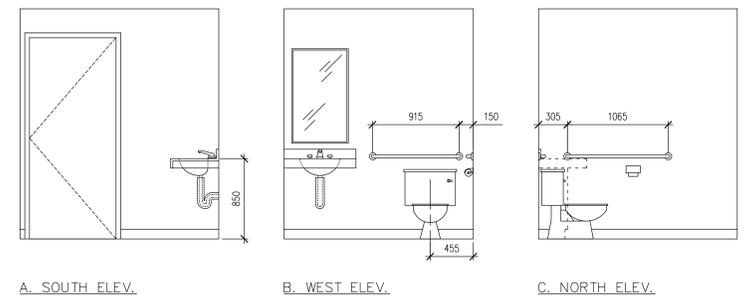

3 MQ-205 - ELEVATIONS  
A412/A421 1:25
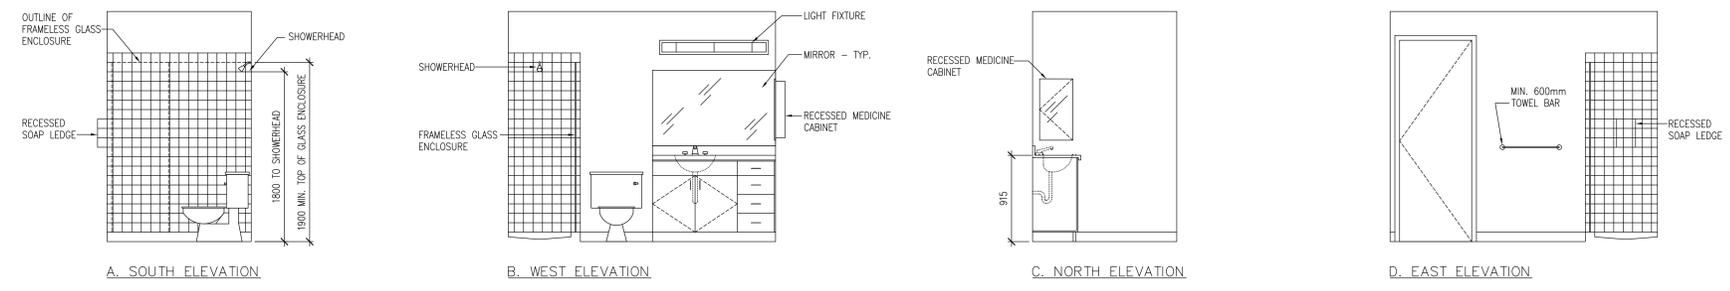
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Rev. Number	Description	Date

Release For Construction:		NIB/AS
Drawing Title <b>ENLARGED INTERIOR ELEVATIONS</b>		
DBD Project Number	Drawing Scale	Phase
	AS NOTED	04*
CAD File Name	CAD Plot Scale	<input type="checkbox"/> CONCEPT <input type="checkbox"/> 10% <input type="checkbox"/> 30% <input type="checkbox"/> 50% <input type="checkbox"/> 75% <input type="checkbox"/> 100%
CBMA422.DWG	1:1	
Date	Sheet Number	
NOV-2012		
Drawn By	Checked By	Project Number
NIBS	NIBS	Barracks A421
Classification	UNCLASSIFIED	

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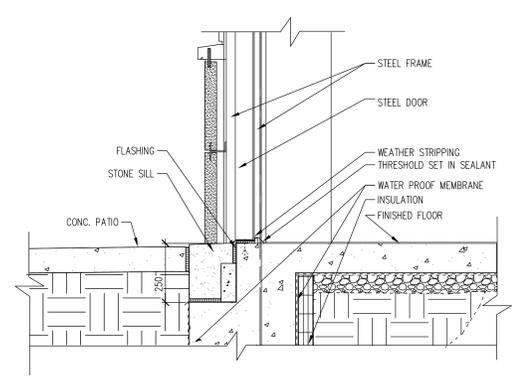
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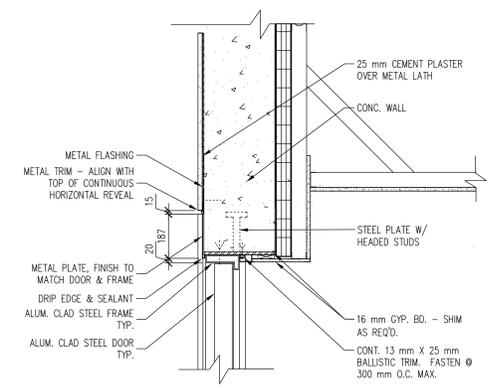
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Building Information Model  
Common File


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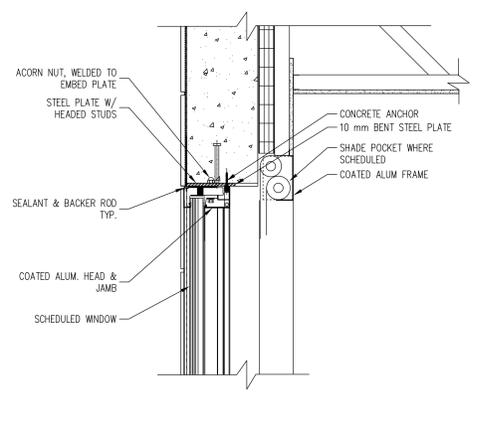
**1 DOOR DETAIL- SILL**  
A302 | A501 1:10




**2 DOOR DETAIL**  
A302 | A501 1:10



**3 WINDOW SILL DETAIL (B-1)**  
A302 | A501 1:10

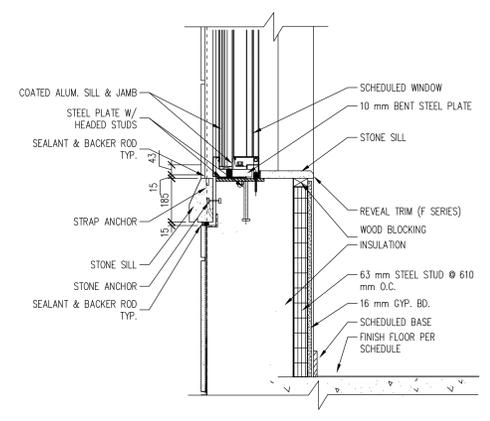

**4 WINDOW HEAD DETAIL (B-1)**  
A302 | A501 1:10

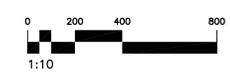

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Rev. Number	Description	Date
Revisions		

Release For Construction:	
NIB/AS	NIB/AS
Drawing Title <b>EXTERIOR WALL DETAILS</b>	
DBO Project Number	Drawing Scale Phase
AS NOTED	CONCEPT [ ] 10% [ ] 20% [ ] 30% [ ] 40% [ ] 50% [ ] 60% [ ] 70% [ ] 80% [ ] 90% [ ] 100%
CAD File Name	CAD Plot Scale
CBMA501.DWG	1:1
Date	Sheet Number
NOV-2012	Barracks
Drawn By	Checked By
NIBS	NIBS
Project Number	Classification
A501	UNCLASSIFIED

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1 2 3 4 5 6 7 8 9 10 11 12 13 14 15 16 17 18







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# Barracks 101

## Building Information Model Common File

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Rev. Number	Description	Date
Revisions		

### STAIR DETAILS

080 Project Number	Drawing Scale	Phase
CBMAS11.DWG	AS NOTED	04
CAED File Name	CAED Plot Scale	CONCEPT
CBMAS11.DWG	1:1	CONCEPT
Date	NOV-2012	Sheet Number
Drawn By	NIBS	Barracks
Checked By	NIBS	A511
Project Number		
Classification	UNCLASSIFIED	
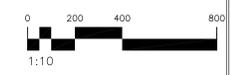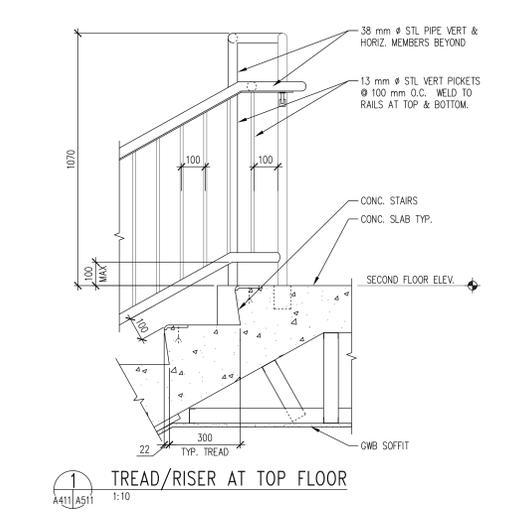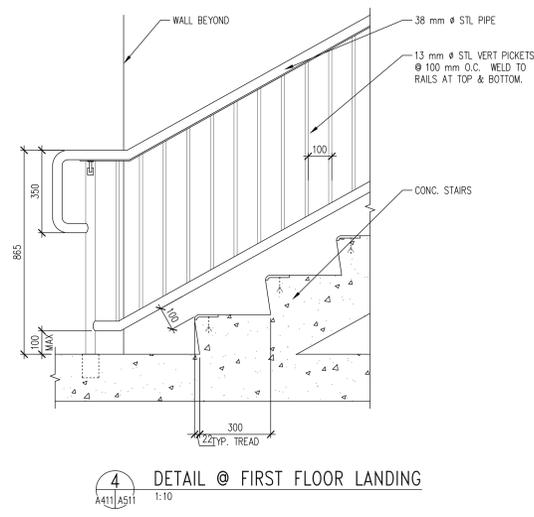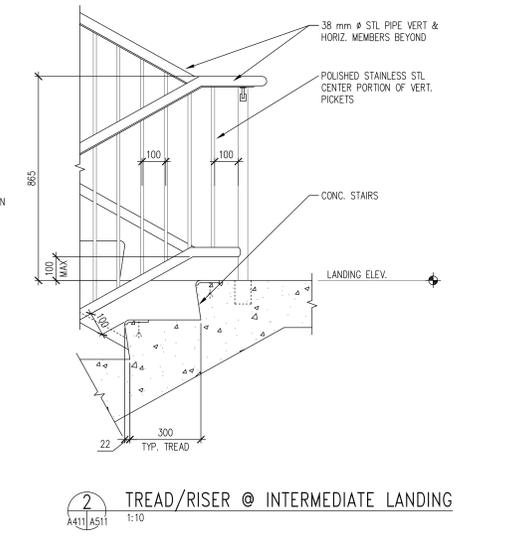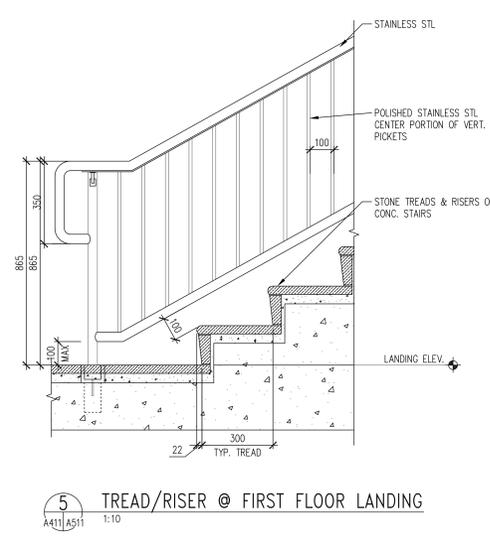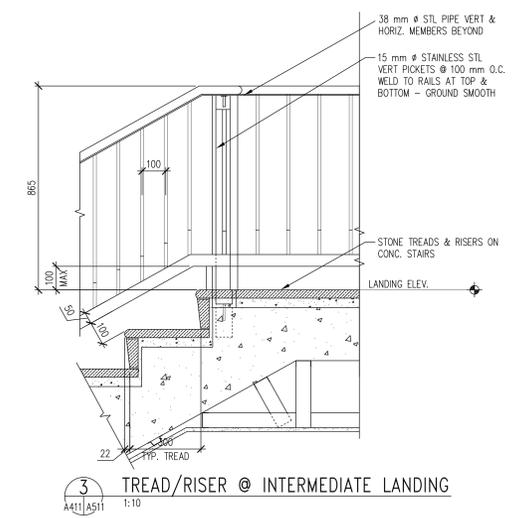
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BARRACKS WINDOW SCHEDULE EXTERIOR						
WINDOW NUMBER	OPE WINDOW TYPE	WINDOW LOCATION	BUILDING LEVEL	FEBR CODE / WINDOW RATING	GLAZING TYPE	WINDOW SIZE
1	B-1	EXTERIOR ELEVATION	VARIABLE	1123 + BLAST	SEE NOTE #1	SEE NOTE #2
2	G-1	EXTERIOR ELEVATION	VARIABLE	1123 + BLAST	SEE NOTE #1	SEE NOTE #2
3	E-1	EXTERIOR ELEVATION	VARIABLE	1123 + BLAST	SEE NOTE #1	SEE NOTE #2
4	A-1	EXTERIOR ELEVATION	VARIABLE	1123 + BLAST	SEE NOTE #1	SEE NOTE #2
5	C-1	EXTERIOR ELEVATION	VARIABLE	1123 + BLAST	SEE NOTE #1	SEE NOTE #2
6	132-R	EXTERIOR ELEVATION	VARIABLE	1123 + BLAST	SEE NOTE #1	SEE NOTE #2


\* REFER TO DOOR SHOP DRAWINGS FOR DOOR HARDWARE

**OPE NOTES**


PROJECTS WITH A SCOPE OF WORK THAT INCLUDE OPE (OWNER PROCURED EQUIPMENT) WILL RECEIVE PRODUCT SHOP DRAWINGS FOR EACH WINDOW TYPE. OPE SHOP DRAWINGS SUPERCEDE SBD DRAWINGS FOR WINDOW SIZE AND DETAILS. SBD DRAWINGS SHOULD BE USED TO REFERENCE WINDOW TYPE LOCATION.

**NOTES:**


- 1- FOR OPE - REFER TO PRODUCT SHOP DRAWINGS AND REPORT FOR NON-OPE - GLAZING TYPE & THICKNESS TO BE DETERMINED BY WINDOW RATING DESIGN CRITERIA.
- 2- FOR OPE - REFER TO PRODUCT SHOP DRAWINGS FOR NON-OPE - WINDOW SIZE = ROUGH OPENING - SHIM SPACE
- 3- ROUGH OPENING DOES NOT INCLUDE SUBFRAME OR EMBED ROUGH OPENING = WINDOW UNIT + SHIM SPACE

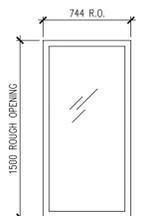


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A201/A601 1:20

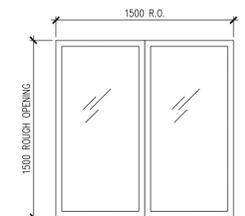


2 WINDOW TYPE 2 (G-1)  
A201/A601 1:20

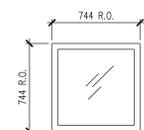


3 WINDOW TYPE 3 (E-1)  
A201/A601 1:20

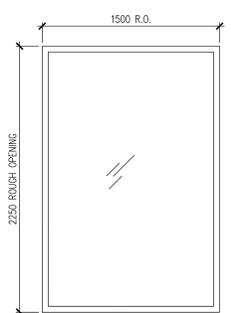

4 WINDOW TYPE 4 (A-1)  
A201/A601 1:20

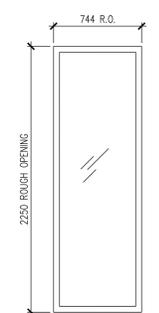

5 WINDOW TYPE 5 (C-1)  
A201/A601 1:20

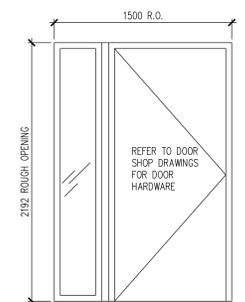

6 WINDOW TYPE 1 (132-R)  
A201/A601 1:20

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**Barracks 101**  
Building Information Model  
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Rev. Number	Description	Date

Release For Construction:  NIB/AS

Drawing Title: **WINDOW SCHEDULE**

SBD Project Number:      Drawing Scope:  AS NOTED  SOW  
 CAD File Name: CBMA601.DWG      CAD Plot Scale:  CONCEPT  10%  20%  30%  40%  50%  60%  70%  80%  90%  100%  
 Date: NOV-2012      Sheet Number:      Drawn By: NIBS  
 Checked By: NIBS  
 Project Number: **A601**  
 Classification: UNCLASSIFIED

















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# BARRACKS 101 DOOR SCHEDULE

OPF NUMBER	RM/DOOR NUMBER	DOOR SIZE			DOOR TYPE	DOOR MATERIAL	DOOR FINISH	GLAZING TYPE	FEBR CODE	FRAME TYPE	FRAME MATERIAL	FRAME FINISH	FRAME DETAILS			FIRE CLASS	LABEL RATING	HARDWARE SET	REMARKS
		WIDTH	HEIGHT	THICKNESS									HEAD	JAMB	SILL				
131-R	101A	940	2135	52	D1	STEEL	SS	-	2123	F1	STEEL	SS	H-3	J-2	S-14	-	-	SHW-25A	
	101B	915	2135	45	D4	WD	PF	-	-	F1	HM	PNT	H-1	J-1	S-21	-	-	110	
	102	915	2135	45	D1	WD	PF	-	-	F1	HM	PNT	H-1	J-1	S-21	-	-	111	
	103	915	2135	45	D1	WD	PF	-	-	F1	HM	PNT	H-1	J-1	S-21	-	-	111	
	104	915	2135	45	D1	WD	PF	-	-	F1	HM	PNT	H-1	J-1	S-21	-	-	116	
121-R	105	PR 915	2135	52	D2	STEEL	SS	-	2333	F2	STEEL	SS	H-3	J-2	S-14	-	-	SHW-19A	
	106	762	2135	45	D1	WD	PF	-	-	F1	HM	PNT	H-1	J-1	S-4	-	-	111	
	107	762	2135	45	D1	WD	PF	-	-	F1	HM	PNT	H-1	J-1	S-21	-	-	110	
	108	915	2135	45	D1	WD	PF	-	-	F1	HM	PNT	H-1	J-1	S-4	-	-	140	
	109	915	2135	45	D1	WD	PF	-	-	F1	HM	PNT	H-1	J-1	S-21	-	-	116	
	110	915	2135	45	D1	WD	PF	-	-	F1	HM	PNT	H-1	J-1	S-21	-	-	110	
	111	915	2135	45	D1	WD	PF	-	-	F1	HM	PNT	H-1	J-1	S-21	-	-	116	
	112	915	2135	45	D1	WD	PF	-	-	F1	HM	PNT	H-1	J-1	S-21	-	-	140	
	113	915	2135	45	D1	WD	PF	-	-	F1	HM	PNT	H-1	J-1	S-9	-	-	116	
121-R	115	PR 915	2135	52	D2	STEEL	SS	-	2333	F2	STEEL	SS	H-3	J-2	S-14	-	-	SHW-19A	
131-R	116A	940	2135	52	D1	STEEL	SS	-	2123	F1	STEEL	SS	H-3	J-2	S-14	-	-	SHW-25A	
	116B	915	2135	45	D1	WD	PF	-	-	F1	HM	PNT	H-1	J-1	S-21	-	-	106	
131-L	118A	940	2135	52	D1	STEEL	SS	-	2123	F1	STEEL	SS	H-3	J-2	S-14	-	-	SHW-25A	
131-L	118B	940	2135	52	D1	STEEL	SS	-	2123	F1	STEEL	SS	H-3	J-2	S-14	-	-	SHW-25A	
	119	915	2135	45	D1	WD	PF	-	-	F1	HM	PNT	H-1	J-1	S-9	-	-	110	
	120	915	2135	45	D1	WD	PF	-	-	F1	HM	PNT	H-1	J-1	S-21	-	-	116	
	121	915	2135	45	D4	WD	PF	K	-	F1	HM	PNT	H-1	J-1	S-21	-	-	110	
	122	915	2135	45	D1	WD	PF	-	-	F1	HM	PNT	H-1	J-1	S-9	-	-	110	
132-R	123	940	2135	52	D6	STEEL	SS	-	1123	F1	STEEL	SS	H-3	J-2	S-14	-	-	SHW-25	
	124	915	2135	45	D1	WD	PF	-	-	F1	HM	PNT	H-1	J-1	S-21	-	-	110	

LEVEL TWO

201	915	2135	45	D1	WD	PF	-	-	-	F1	HM	PNT	H-1	J-1	S-5	-	-	116A	
202	915	2135	45	D1	WD	PF	-	-	-	F1	HM	PNT	H-1	J-1	S-5	-	-	SHW-14	
203	915	2135	45	D1	WD	PF	-	-	-	F1	HM	PNT	H-1	J-1	S-9	-	-	116A	
203A	610	2135	45	D1	WD	PF	-	-	-	F1	HM	PNT	H-1	J-1	S-9	-	-	110	
203B	PR 762	2135	45	D1	WD	PF	-	-	-	F2	HM	PNT	H-1	J-1	S-9	-	-	123	
204	762	2135	45	D1	WD	PF	-	-	-	F1	HM	PNT	H-1	J-1	S-4	-	-	111	
205	915	2135	45	D1	WD	PF	-	-	-	F1	HM	PNT	H-1	J-1	S-9	-	-	116A	
205A	610	2135	45	D1	WD	PF	-	-	-	F1	HM	PNT	H-1	J-1	S-9	-	-	110	
205B	PR 762	2135	45	D1	WD	PF	-	-	-	F2	HM	PNT	H-1	J-1	S-9	-	-	123	
206	762	2135	45	D1	WD	PF	-	-	-	F1	HM	PNT	H-1	J-1	S-4	-	-	111	
207	915	2135	45	D1	WD	PF	-	-	-	F1	HM	PNT	H-1	J-1	S-9	-	-	116A	
207A	610	2135	45	D1	WD	PF	-	-	-	F1	HM	PNT	H-1	J-1	S-9	-	-	110	
207B	PR 762	2135	45	D1	WD	PF	-	-	-	F2	HM	PNT	H-1	J-1	S-9	-	-	123	
208	762	2135	45	D1	WD	PF	-	-	-	F1	HM	PNT	H-1	J-1	S-4	-	-	111	
209	915	2135	45	D1	WD	PF	-	-	-	F1	HM	PNT	H-1	J-1	S-9	-	-	116A	
209A	610	2135	45	D1	WD	PF	-	-	-	F1	HM	PNT	H-1	J-1	S-9	-	-	110	
209B	PR 762	2135	45	D1	WD	PF	-	-	-	F2	HM	PNT	H-1	J-1	S-9	-	-	123	
210	762	2135	45	D1	WD	PF	-	-	-	F1	HM	PNT	H-1	J-1	S-4	-	-	141	
211	915	2135	45	D1	WD	PF	-	-	-	F1	HM	PNT	H-1	J-1	S-9	-	-	116A	
211A	610	2135	45	D1	WD	PF	-	-	-	F1	HM	PNT	H-1	J-1	S-9	-	-	110	
211B	PR 762	2135	45	D1	WD	PF	-	-	-	F2	HM	PNT	H-1	J-1	S-9	-	-	123	
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213	915	2135	45	D1	WD	PF	-	-	-	F1	HM	PNT	H-1	J-1	S-9	-	-	116A	
213A	610	2135	45	D1	WD	PF	-	-	-	F1	HM	PNT	H-1	J-1	S-9	-	-	110	
213B	PR 762	2135	45	D1	WD	PF	-	-	-	F2	HM	PNT	H-1	J-1	S-9	-	-	123	
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215	915	2135	45	D1	WD	PF	-	-	-	F1	HM	PNT	H-1	J-1	S-9	-	-	116A	
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215B	PR 762	2135	45	D1	WD	PF	-	-	-	F2	HM	PNT	H-1	J-1	S-9	-	-	123	
216	762	2135	45	D1	WD	PF	-	-	-	F1	HM	PNT	H-1	J-1	S-4	-	-	111	
217A	915	2135	45	D1	WD	PF	-	-	-	F1	HM	PNT	H-1	J-1	S-5	-	-	90	106A
217B	915	2135	45	D1	WD	PF	-	-	-	F1	HM	PNT	H-1	J-1	S-5	-	-	90	106A

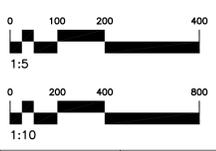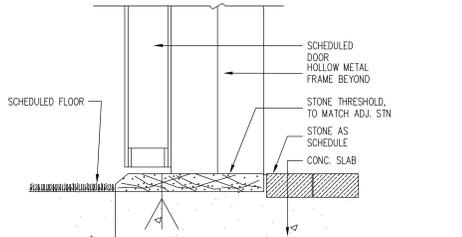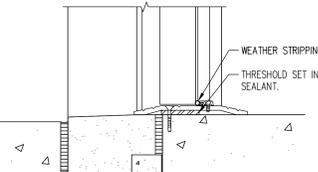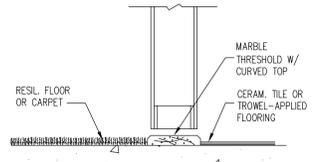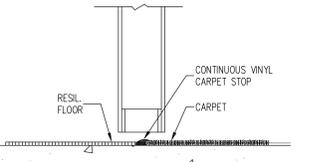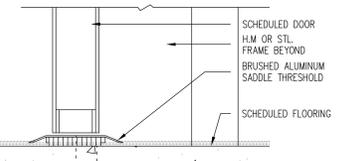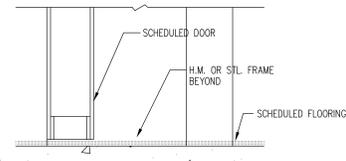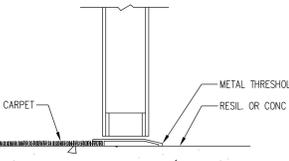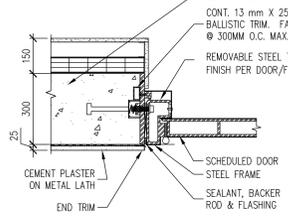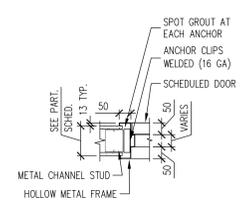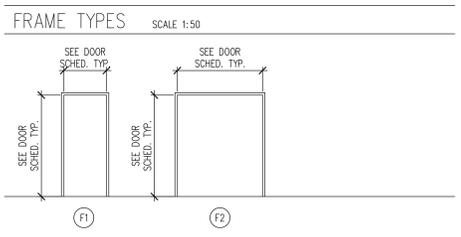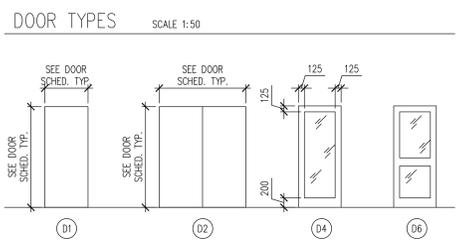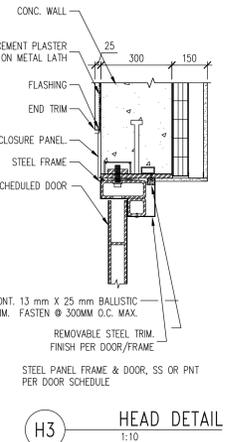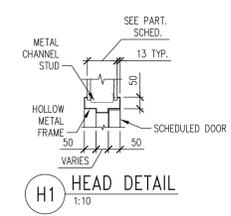

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## Barracks 101

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Rev. Number	Description	Date

Release For Construction: NIBS/Asa


Drawing Title: **DOOR SCHEDULE AND DETAILS**

GEO Project Number: CBMA602.DWG  
Drawing Scale: 1:1  
Phase: AS NOTED  
GOM


Date: NOV-2012  
Sheet Number: **A602**

Drawn By: NIBS  
Checked By: NIBS  
Project Number: **Barracks**  
Classification: UNCLASSIFIED



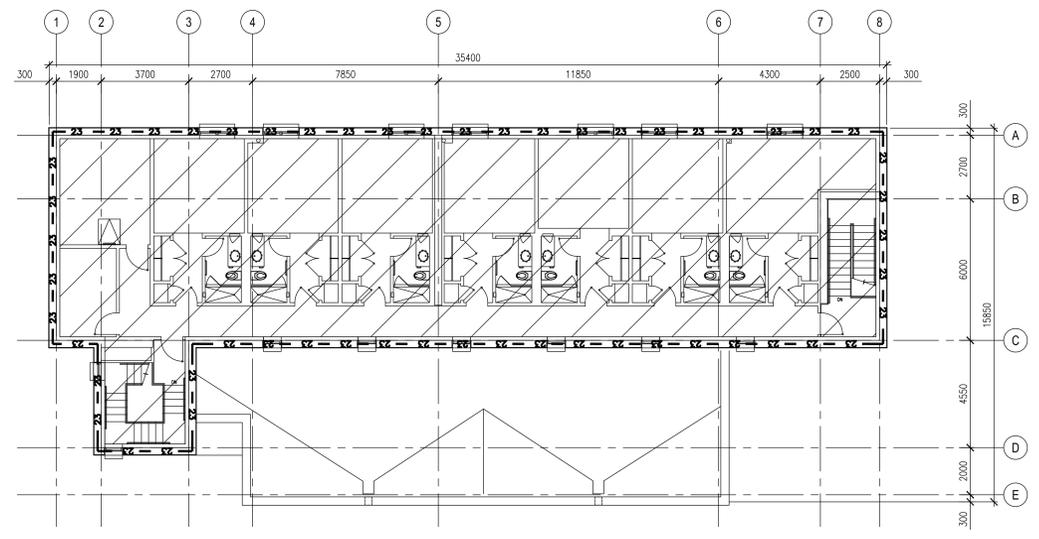

1  
AW111  
LEVEL TWO SPECIAL WALL PLAN  
1:100

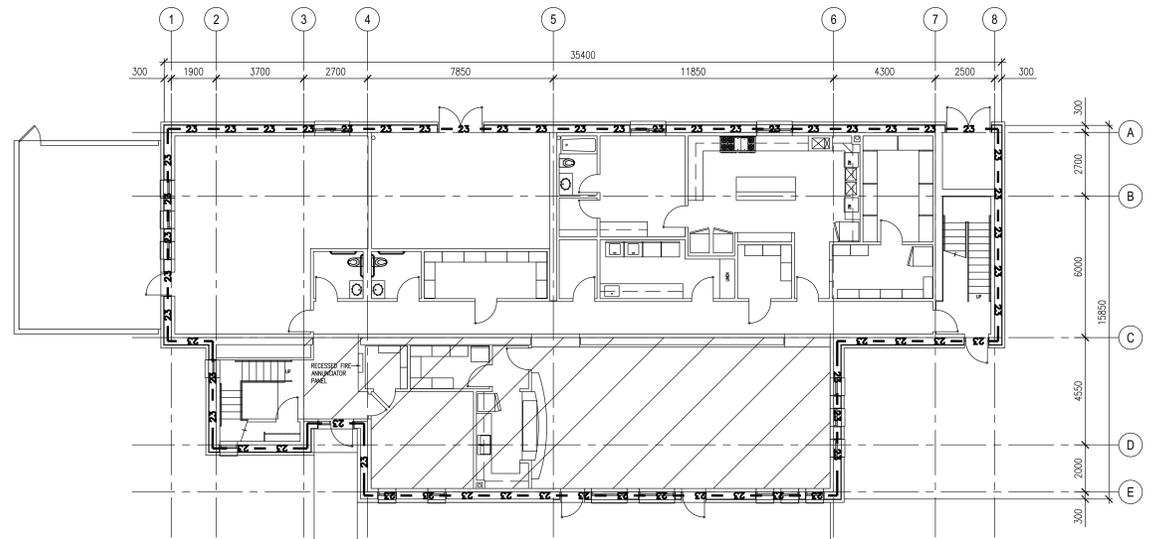

2  
AW111  
LEVEL ONE SPECIAL WALL PLAN  
1:100

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**Barracks 101**  
Building Information Model  
Common File


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**LEGEND**  
\*\*23 WALL TYPE (15 MINUTE FE/BR)  
\*\*23 CEILING SLAB (15 MINUTE FE/BR)

**GENERAL NOTES**  
PROVIDE PROTECTION TO ALL PENETRATIONS THROUGH WALL EQUAL TO WALL REQUIREMENT

Rev. Number	Description	Date
Revisions		


Release For Construction:		NIB/AS	
Drawing Title <b>SPECIAL WALL FLOOR PLANS</b>			
IBD Project Number	Drawing Scale	Phase	AS NOTED
CBMAW111.DWG	1:1	CONCEPT	10% 20% 30% 40% 50% 60% 70% 80% 90% 100%
Date	NOV-2012	Sheet Number	
Drawn By		Checked By	NIBS
Project Number		Classification	UNCLASSIFIED

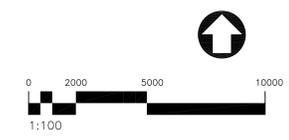

ALL DIMENSIONS WITHOUT A DECIMAL ARE IN MILLIMETERS UNO. ALL DIMENSIONS WITH A DECIMAL ARE IN METERS UNO.

1 2 3 4 5 6 7 8 9 10 11 12 13 14 15 16 17 18

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**1**  
E111  
**GROUNDING AND LIGHTNING PROTECTION PLAN**  
1:100

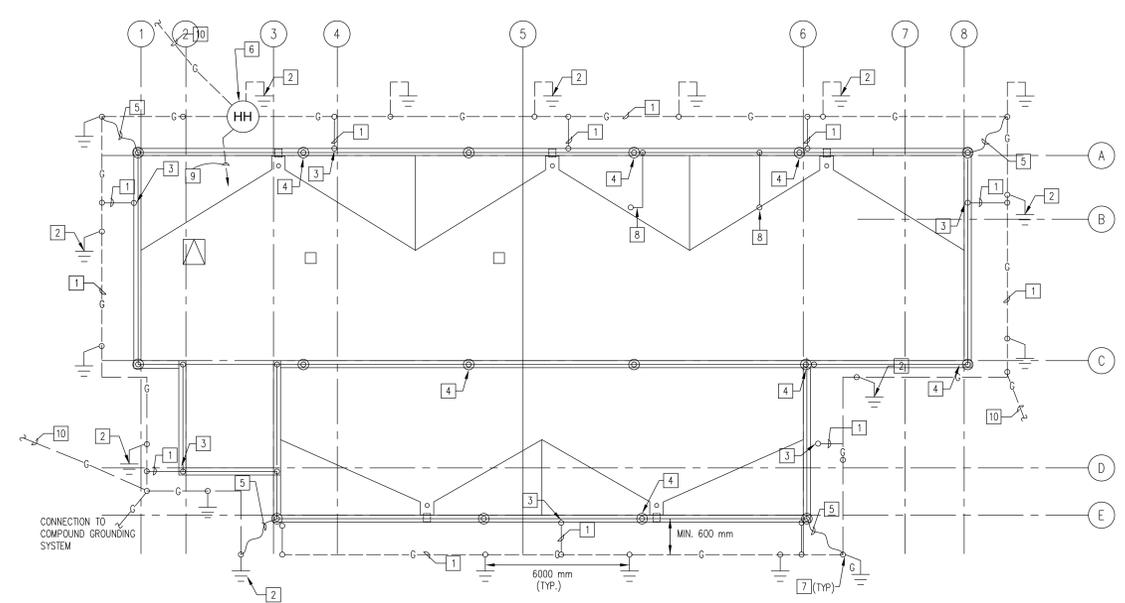**CODED NOTES:**

- 1 BARE, STRANDED, COPPER CONDUCTOR 460 mm BELOW FINISHED GRADE.
- 2 COPPER CLAD STEEL GROUND ROD.
- 3 GROUND CONNECTION TO THE CONCRETE REINFORCING STEEL, BOND TO REINFORCING STEEL IN EACH COLUMN.
- 4 AIR TERMINAL.
- 5 LIGHTNING PROTECTION CONDUCTOR, PROVIDE PVC CONDUIT CAST INTO THE EXTERIOR WALL FOR EACH DOWN CONDUCTOR.
- 6 LIGHTNING PROTECTION CONDUCTOR.
- 7 HAND HOLE.
- 8 BOND ALL ROOFTOP MECHANICAL EQUIPMENT AND OTHER METALLIC ENCLOSURES TO LIGHTNING PROTECTION SYSTEM. REFER TO MECHANICAL AND ARCHITECTURAL DRAWINGS FOR LOCATIONS.
- 9 CABLE TO MAIN GROUND BUS BAR, SEE SHEET GEN E502 DETAIL 3 & 4.
- 10 CONNECT TO ADJACENT GROUNDING COUNTERPOISE SYSTEM. REFER TO DRAWING OMPD XXXX.

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**Building Information Model**  
**Common File**


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Washington, DC 20005

**GENERAL NOTES:**

1. SEE SHEETS GEN E001, E501, E502, E503, & E504 FOR ADDITIONAL INFORMATION.
2. EQUIPMENT LAYOUTS AND COMPONENTS SHOWN ARE SCHEMATIC IN NATURE AND REPRESENT A DESIGN INTENT ONLY. EQUIPMENT SHOWN DOES NOT REFLECT THE ENTIRETY OF ALL SYSTEMS REQUIRED. ACTUAL EQUIPMENT INSTALLED AND FINAL SIZES AND LOCATIONS ARE TO BE PROVIDED BASED ON SITE SPECIFIC CONDITIONS AND GBO DESIGN REQUIREMENTS, STANDARDS, AND SPECIFICATIONS.
3. ALL GROUND CONNECTIONS FOR BUILDING GROUNDING SYSTEM SHALL BE EXOTHERMIC WELD (CADWELD OR EQUAL) AND ROOFTOP LIGHTNING PROTECTION SYSTEM CONNECTIONS SHALL BE MECHANICAL OR EXOTHERMIC WELD TYPE. REFER TO DETAILS ON SHEET GEN E501.
4. THIS PLAN INDICATES MINIMUM REQUIREMENTS FOR LOCATION AND ROUTING OF LIGHTNING PROTECTION SYSTEM COMPONENTS AND CONDUCTORS AND IS NOT INTENDED TO ILLUSTRATE A COMPLETE DESIGN. A LPI CERTIFIED MASTER LIGHTNING PROTECTION SYSTEM DESIGNER/INSTALLER SHALL BE RESPONSIBLE FOR THE COMPLETE DESIGN OF A U.L. MASTER LABEL CERTIFIED SYSTEM. ALL MATERIALS SHALL BE AS REQUIRED PER NFPA 780.
5. ADD BENTONITE (A CLAY) SLURRY MATERIAL TO SOIL SURROUNDING GROUND RODS AND COUNTERPOISE CONDUCTOR WHEN SOIL IS ROCKY OR SANDY, OR IN PARTICULAR DRY CLIMATES, IN ACCORDANCE WITH MIL-HDBK-419A. MIL-HDBK-419A REQUIRES THE BACKFILL SHALL CONSIST OF A MIXTURE OF 75 PERCENT GYPSUM (CALCIUM SULFATE), 20 PERCENT BENTONITE CLAY, AND 5 PERCENT SODIUM SULFATE. ENCASE THE COUNTERPOISE IN A 50 mm ENVELOPE OF SLURRY OF THE BACKFILL MATERIAL. INSTALL GROUND RODS IN 150 mm DIAMETER AUGURED HOLES. BACKFILL HOLE WITH SLURRY OF THE BACKFILL MATERIAL. THE BACKFILL MATERIAL MUST BE SATURATED WITH WATER AFTER INITIAL INSTALLATION AND BE TOPPED WITH A 300 mm LAYER OF EXCAVATED SOIL.
6. AN ALTERNATE TO BENTONITE SLURRY MATERIAL IS TO ADD ERICO'S GROUND ENHANCEMENT MATERIAL (GEM) OR EQUAL TO GROUND RODS AND THE COUNTERPOISE CONDUCTOR. INSTALL THE GEM IN ACCORDANCE WITH THE MANUFACTURER'S INSTALLATION GUIDES.
7. IN CERTAIN HIGH RESISTIVITY SOILS, THE USE OF CHEMICALLY TREATED GROUND RODS SHALL BE CONSIDERED.
8. GROUND SYSTEM IMPEDANCE NOT TO EXCEED 10 OHMS.
9. ALL MATERIALS SHALL BE AS REQUIRED IN NFPA 780.
10. ALL AIR TERMINALS SHALL BE A MINIMUM OF 600 mm IN LENGTH.
11. ALL HANDHOLE AND MANHOLE COVERS MUST BE LOCKING TYPE/LOCKABLE.

Rev. Number	Description	Date
Revisions		

Release For Construction:		NIBS/Asa	
Drawing Title: <b>GROUNDING &amp; LIGHTNING PROTECTION PLAN</b>			
GBO Project Number	Drawing Scale	Phase	AS NOTED
CBME111.DWG	1:1	CONCEPT	CONCEPT
Date	NOV-2012	Sheet Number	
Drawn By	NIBS	Barracks	
Checked By	NIBS	E111	
Project Number			
Classification	UNCLASSIFIED		

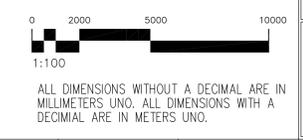

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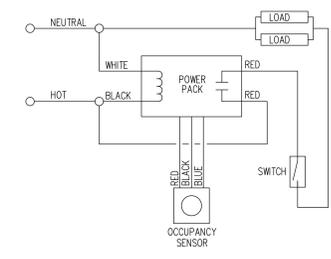
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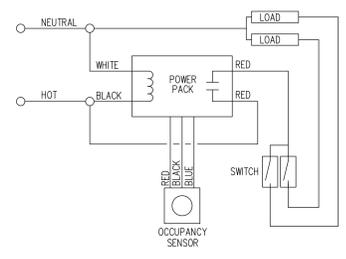
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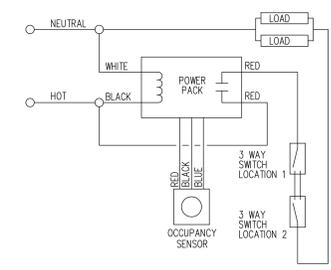
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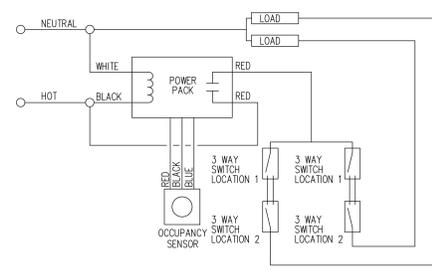
CONTROL FOR SINGLE LEVEL SWITCHING




CONTROL FOR DOUBLE LEVEL SWITCHING




CONTROL FOR SINGLE LEVEL SWITCHING FROM 2 LOCATIONS



CONTROL FOR DOUBLE LEVEL SWITCHING FROM 2 LOCATIONS

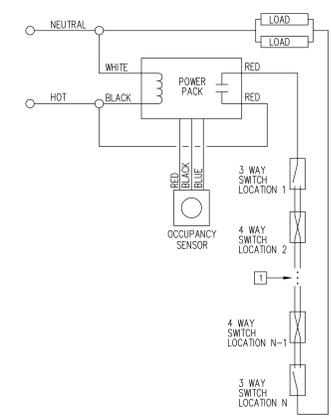

CONTROL FOR SINGLE LEVEL SWITCHING FROM N LOCATIONS

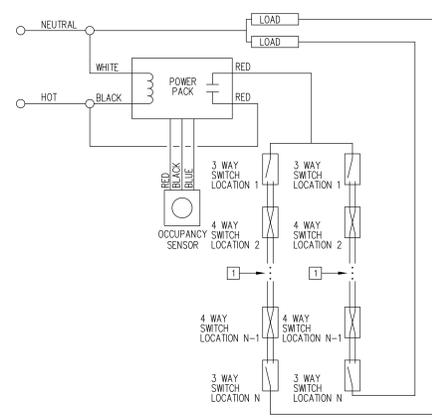

CONTROL FOR DOUBLE LEVEL SWITCHING FROM N LOCATIONS

**CODED NOTES:**  
 [1] AS MANY 4-WAY SWITCHES AS ARE NECESSARY, MAY BE INSERTED HERE SO THAT THE TOTAL NUMBER OF SWITCH LOCATIONS "N" MAY BE ANY NUMBER GREATER THAN 2.

1 OCCUPANCY SENSOR CONTROLS FOR INTERIOR LIGHTING  
 E511 NIS

Rev. Number	Description	Date

Release For Construction: NIS/As

Drawing Title: **POINT TO POINT WIRING DIAGRAMS**

DBD Project Number: AS NOTED Phase: CONCEPT

CAD File Name: CME511.DWG CAD Plot Scale: 1:1

Date: NOV-2012 Sheet Number: 1

Drawn By: NIBS  
 Checked By: NIBS  
 Project Number: Barracks E511  
 Classification: UNCLASSIFIED

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LIGHTING FIXTURE SCHEDULE

TYPE	DESCRIPTION	LENSE/ LOUVER	AIR FUNCTION	MOUNTING	VOLTS	LAMP DATA			MANUFACTURER AND CATALOG NO.	NOTES		
						NO.	WATTS	CODE				
B	SURFACE MOUNTED FIXTURE (BEDROOMS)	○	N/A	CS	220 50HZ	2	26	26W DOUBLE	LUMAX SP OR APPROVED EQUAL	SURFACE ROUND, 35.5 cm DIA		
C	1219 mm LONG INDUSTRIAL ELECTRONIC BALLAST, RF FILTER AS NOTED	⊖	N/A	CC	220 50HZ	3	32	F32T8	DAY-BRITE #F332T8PP/220 OR APPROVED EQUAL	MOUNT FIXTURE 2438 mm AFF.		
E1	L.E.D. EXIT SIGN, EMERG BATTERY BACK-UP	⊖	N/A	AS SHOWN	220 50HZ	-	-	LED	MCPHILLBEN # 30LC1R/220 OR APPROVED EQUAL	CHEVRONS TO BE KNOCKED OUT ON SITE ACCORDING TO DRAWINGS		
E2	L.E.D. EXIT SIGN, EMERG BATTERY BACK-UP	⊖	N/A	AS SHOWN	220 50HZ	-	-	LED	MCPHILLBEN # 30LC2R/220 OR APPROVED EQUAL	CHEVRONS TO BE KNOCKED OUT ON SITE ACCORDING TO DRAWINGS		
F	EMER. BATTERY PACK FIXTURE, 12V, STEEL HOUSING NI-CAD BATTERY	⊖	N/A	WS 2438 mm AFF	220 50HZ	2	9	-	LITHONIA #ELMANS5B OR APPROVED EQUAL			
K	COMPACT FLUORESCENT DOWNLIGHT	⊖	N/A	CR	220 50HZ	1	32	32W TRIPLE	LIGHTOLIER 8031CLW 6132BU - 220V			
N	L.E.D. WALL MOUNTED M.H. DIECAST ALUMINUM W/LENS	⊖	IMPACT RESISTANT TEMPERED CLASS	SEE ARCH PLANS	220 50HZ	1	37W	HPS	NORTH AMERICAN ENERGY GROUP NFA-37	MEAN LUMENS EQUIVALENT TO 150W METAL HALIDE		
W	SURFACE MOUNTED FLUORESCENT DECORATIVE FIXTURE, ELECTRONIC BALLAST	○	N/A	CS	220 50HZ	2	32	F32T8	LITHONIA #1064032/220/GE8 OR APPROVED EQUAL	SINGLE BALLAST		
WF	WALL BRACKET FLUORESCENT	⊖	N/A	WS	220 50HZ	2	32	F32T8	LITHONIA #MP-2-32-ACF 125-220-GE81015 OR APPROVED EQUAL			
MOUNTING:					AIR FUNCTION							
CS		CEILING, SURFACE		CC#		CEILING, SUSPENDED # FEET AFF		AIR			AIR SUPPLY/RETURN	
CR		CEILING, RECESSED, ACOUSTIC CEILING TILE		WS#		WALL MOUNTED, SURFACE # FEET AFF		HEAT			HEAT REMOVAL	
CG		CEILING, RECESSED, GYPSUM BOARD		WR#		WALL RECESSED, # FEET AFF		DUAL			AIR AND HEAT	
								STATIC			NO AIR FRICTION	

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- GENERAL NOTES:**
- ANY OR ALL FIXTURES SHOWN ON THIS SHEET MAY BE SUBSTITUTED WITH AN APPROXIMATE EQUIVALENT FIXTURE FROM ANOTHER MANUFACTURER. THESE PART NUMBERS ARE SHOWN FOR THE SOLE PURPOSE OF DISPLAYING A CERTAIN DESIGN INTENT.
  - PROVIDE HANDHELD REMOTE CONTROL TEST FOR EXIT AND EMERGENCY LIGHTING UNITS PER SPECIFICATION SECTION 16511. PROVIDE MANUFACTURE OPTION INSTALLED INSIDE FIXTURE FOR BOBINE RCT SERIES OR EQUAL.

Rev Number	Description	Date
Revisions		

Release For Construction:  NIB/AS

Drawing Title: **LIGHTING FIXTURE SCHEDULE**

GEO Project Number:  Drawing Scale:  Phase AS NOTED:  GEO Plot Scale:  1:1


Date: NOV-2012 Sheet Number: **Barracks EL601**

Drawn By: NIBS  
Checked By: NIBS  
Project Number: **EL601**  
Classification: UNCLASSIFIED


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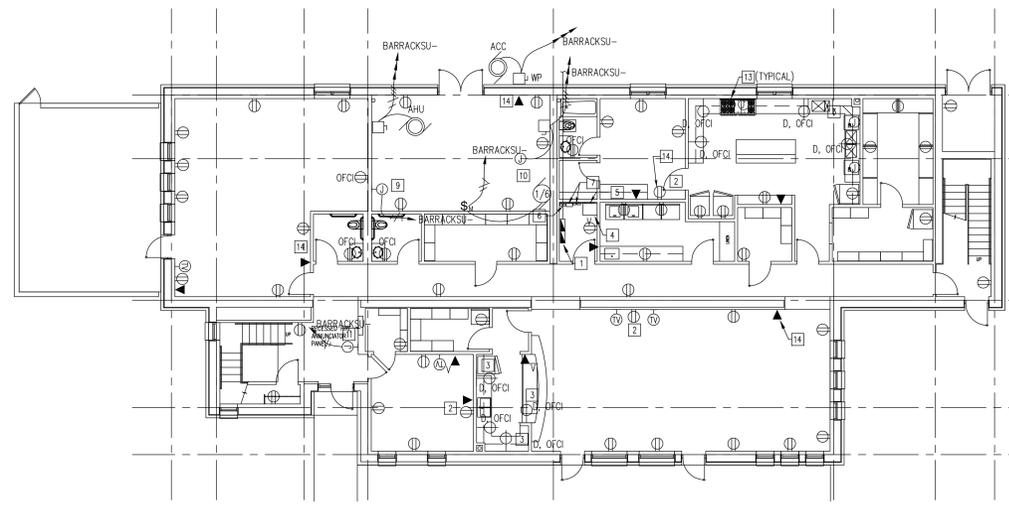
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1 ROOF POWER AND TELECOM PLANS  
1:100



2 LEVEL TWO POWER AND TELECOM PLANS  
1:100

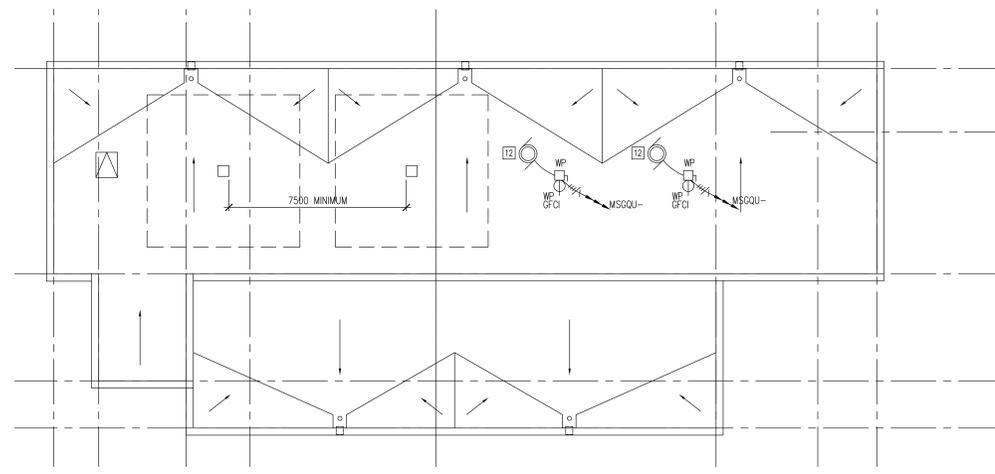

3 LEVEL ONE POWER AND TELECOM PLANS  
1:100

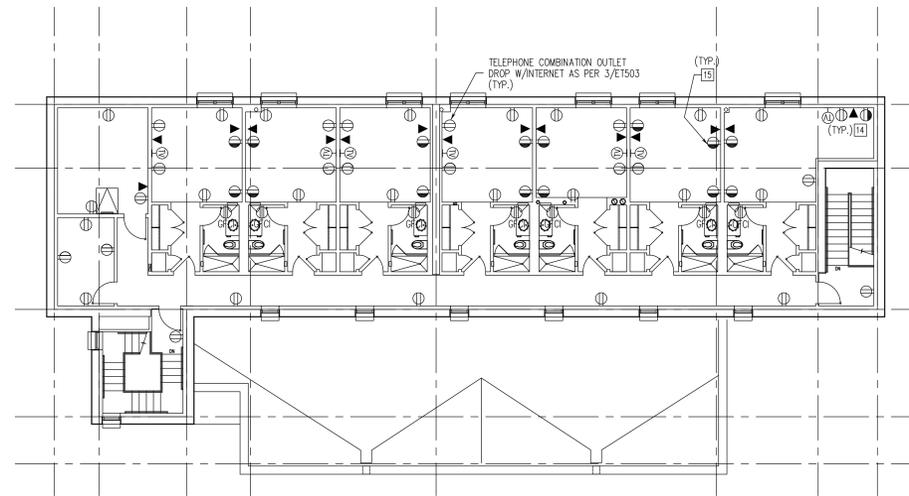NOTE: NO SEPARATE COAX TV "DROPS" DEPICTED. SEE DRAWING MS00 ET503 DETAIL 3.

NOTE: NO SEPARATE COAX TV DROPS.

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**Barracks 101**  
Building Information Model  
Common File

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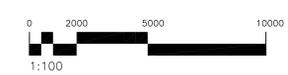
- GENERAL NOTES:**
- ALL ELECTRICAL OUTLETS IN KITCHENS, BATHROOMS, OR ON ROOFTOPS MUST BE GFCI PROTECTED.
  - AS NEMA 6-15 AND 6-20 GFCI RECEPTACLES ARE NOT AVAILABLE, USE AN ENCLOSED GFCI BREAKER MOUNTED ADJACENT TO THE PANELBOARD FEEDING THAT CIRCUIT. USE INTERNATIONAL CONFIGURATIONS TABLE (A-5 mA TRIP) WITH A 40EL SURFACE MOUNT ENCLOSURE, OR EQUAL.
  - COORDINATE EXACT LOCATION OF ALL MECHANICAL EQUIPMENT WITH MECHANICAL DRAWINGS.
  - MOUNT ALL RECEPTACLE DEVICES 380 mm AFF IN ALL LOCATION UNLESS OTHERWISE NOTED.
  - ROUTE ALL CONDUITS FOR BRANCH CIRCUITS IN CEILING ABOVE SPACE, NOT EMBEDDED IN CONCRETE SLAB.
  - ALL VAV BOX DISCONNECT SWITCHES SHALL BE 2 POLE, 30A, 240V RATED. REFER TO MECHANICAL DRAWINGS FOR QUANTITY AND LOCATIONS.

- NOTE:**
- PROVIDE BALLISTIC PROTECTION AT ALL PIPES AND CONDUITS PENETRATING THE FEBR ENVELOPE OF THE BUILDING. SEE NOB DRAWINGS FOR TYPICAL DETAILS.

- CODED NOTES:**
- PANEL BARRACKSUJ CONNECT MOTOR AND LIGHTING LOADS TO SECTION 1 AND SENSITIVE ELECTRONIC AND COMPUTER LOADS TO SECTION 2.
  - INSTALL RECEPTACLE FOR TELEVISION IN REAR OF CABINET. TV'S WILL BE LARGE FLAT SCREEN TV'S EITHER ON ITS OWN BAS OR WALL MOUNTED.
  - MOUNT RECEPTACLE DEVICE 152 mm ABOVE COUNTERTOP.
  - WALL MOUNTED CABINET. REFERENCE ET611 DWG. FOR DETAILS.
  - 19 mm TELECOMMUNICATIONS BACKBOARD.
  - 2-103 mm CONDUIT SLEEVES.
  - PRIMARY PROTECTOR CABINET AND BIX BLOCKS. REFERENCE DWG. ET17.11.
  - PROVIDE 3 PHASE 3 WIRE NFSS, NEMA 1 FOR CONNECTION OF WATER HEATER, 1220 AFF.
  - PROVIDE SINGLE PHASE 20A CIRCUIT FOR DRAIN TRAP PRIMER, 600mm AFF.
  - PROVIDE MOTOR SWITCH FOR DOMESTIC HOT WATER CIRCULATOR. WIRE THROUGH AQUASTAT THAT IS IN LINE WITH CIRCULATOR.
  - PROVIDE SINGLE PHASE, 220V, 20A, DEDICATED, GENERATOR BACKED CIRCUIT TO POWER THE MS00 FACP. TERMINATE IN A 100X100X55 BOX MOUNTED 1500mm AFF. NOTE: BATTERIES MAY BE LOCATED IN AN AUXILIARY CABINET MOUNTED DIRECTLY BELOW THE FACP. ALSO, THIS PANEL REPORTS SUMMARY ALARM AND TROUBLE SIGNALS TO THE NOB FACP LOCATED IN POST 1. PROVIDE A 21 mm EMT CONDUIT FROM THIS LOCATION TO THE CROSS COMPOUND DUCT BANK.
  - EXHAUST FAN
  - JUNCTION BOX FOR KITCHEN EQUIPMENT CONNECTION
  - TYPICAL BEDROOM OUTLET, SEE DETAIL 4/BARRACKS ET503
  - OUTLETS NEXT TO BEDS SHALL BE CONTROLLED FROM WALL SWITCH ON SHEET EL101 (BOTTOM HALF ONLY).

Rev Number	Description	Date
Revisions		

Release For Construction:		NIBS/As	
Drawing Title			
<b>POWER &amp; TELECOM PLANS</b>			
DBD Project Number	Drawing Scale	Phase	Sheet
CEMEP101.DWG	AS NOTED	CONCEPT	104
CAO File Name	CAO Plot Scale	CONCEPT	1:1
Date	NOV-2012	Sheet Number	
Drawn By	NIBS	<b>Barracks EP101</b>	
Checked By	NIBS		
Project Number	NIBS	Classification	
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ALL DIMENSIONS WITHOUT A DECIMAL ARE IN MILLIMETERS UNO. ALL DIMENSIONS WITH A DECIMAL ARE IN METERS UNO.

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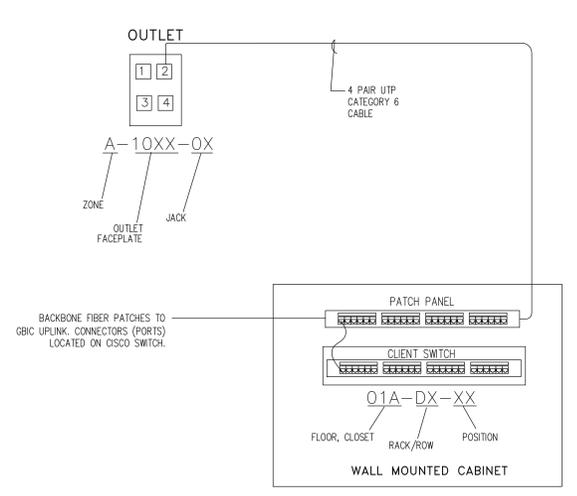
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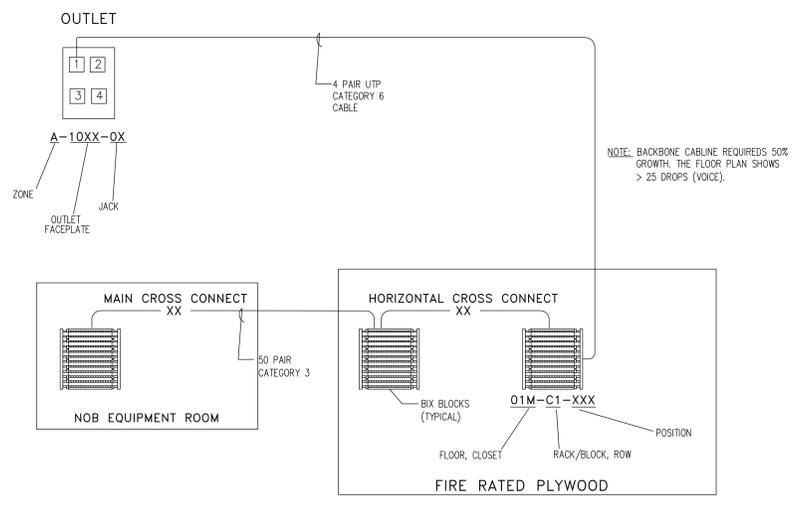
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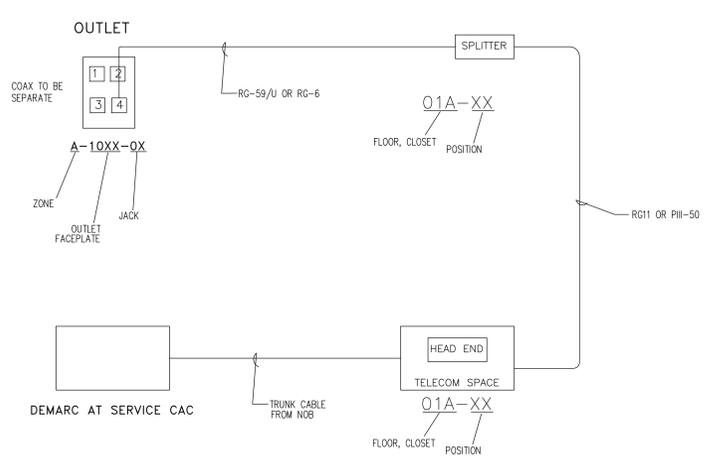
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1 TYPICAL LAN CABLE LAYOUT AND LABELING  
ET501 NTS



2 TYPICAL TELEPHONE CABLE LAYOUT AND LABELING  
ET501 NTS



3 TYPICAL CABLE TELEVISION LAYOUT AND LABELING  
ET501 NTS

Rev. Number	Description	Date
Revisions		



Release For Construction:		NIB/bsa	
Drawing Title: TYPICAL CABLE LAYOUT & LABELING DIAGRAMS			
GBD Project Number	Drawing Scale	Phase	AS NOTED
CBMET501.DWG	1:1	CONCEPT	REV
Date	NOV-2012	Sheet Number	Barracks ET501
Drawn By	NIBS/bsa	Checked By	NIBS/bsa
Project Number		Classification	UNCLASSIFIED

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Building Information Model  
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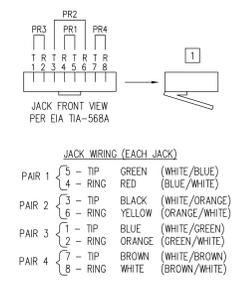
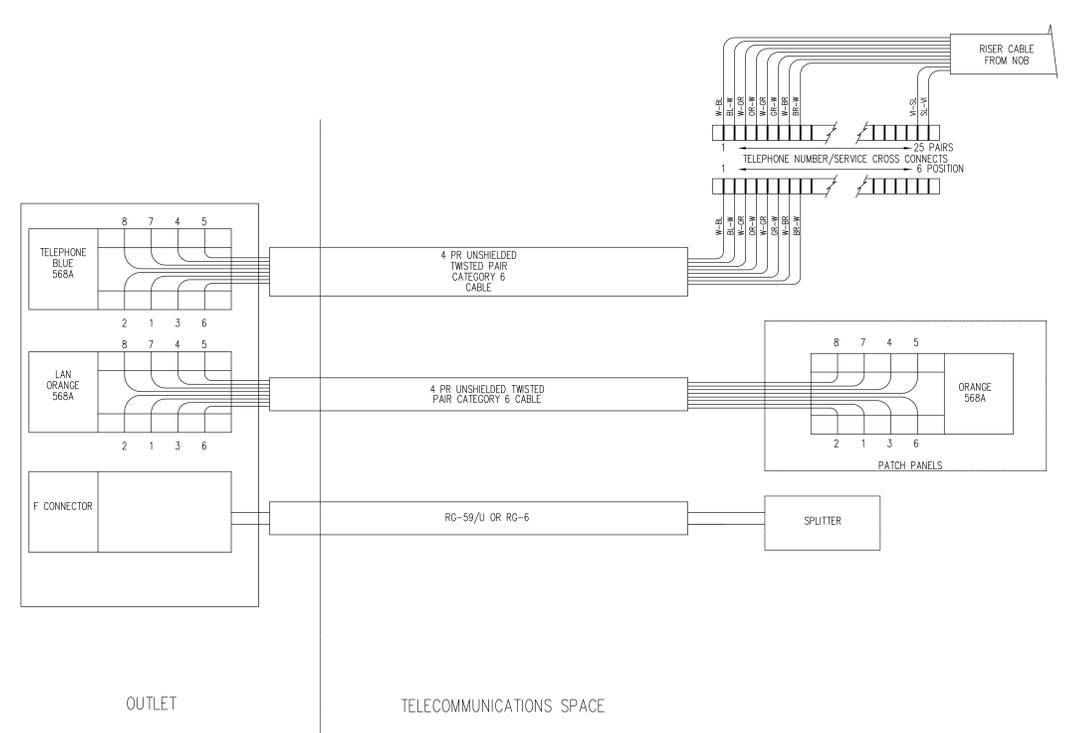
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**CODED NOTES**  
1 8 PIN PLUG PER EIA TIA-568A.



1 ET502  
NTS  
TYPICAL SINGLE LINE DIAGRAM


2 ET502  
NTS  
CONNECTIVITY DIAGRAM - ANCILLARY BUILDINGS

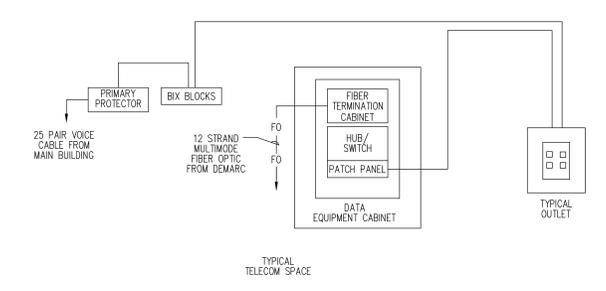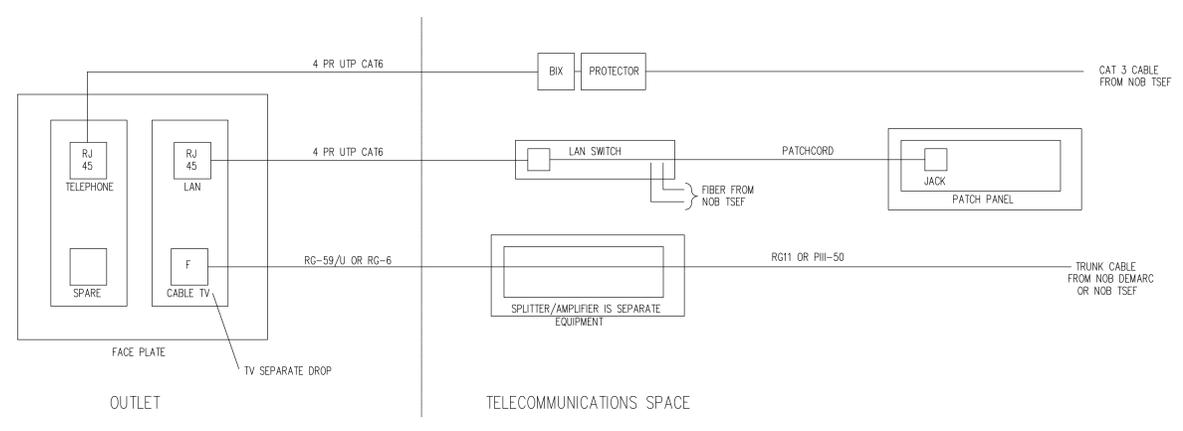


3 ET502  
NTS  
TELECOM OUTLET WIRING DIAGRAM

Rev. Number	Description	Date
Revisions		


Release For Construction:		
NIB/Sa	NIB/Sa	
Drawing Title <b>TELECOM WIRING DIAGRAMS</b>		
DBD Project Number	Drawing Scale	Phase
CBMET502.DWG	ASAP	CONCEPT
Date: NOV-2012		
Drawn By: NIBS/bSa		Sheet Number
Checked By: NIBS/bSa		<b>Barracks ET502</b>
Classification: UNCLASSIFIED		

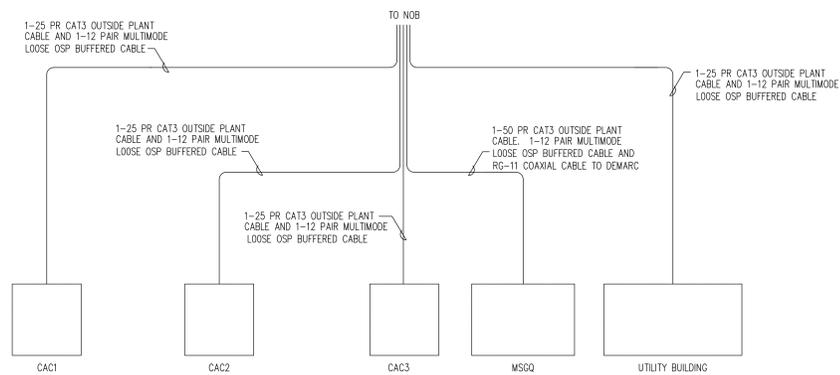


1 TELECOMMUNICATIONS SITE RISER  
ET503 NTS

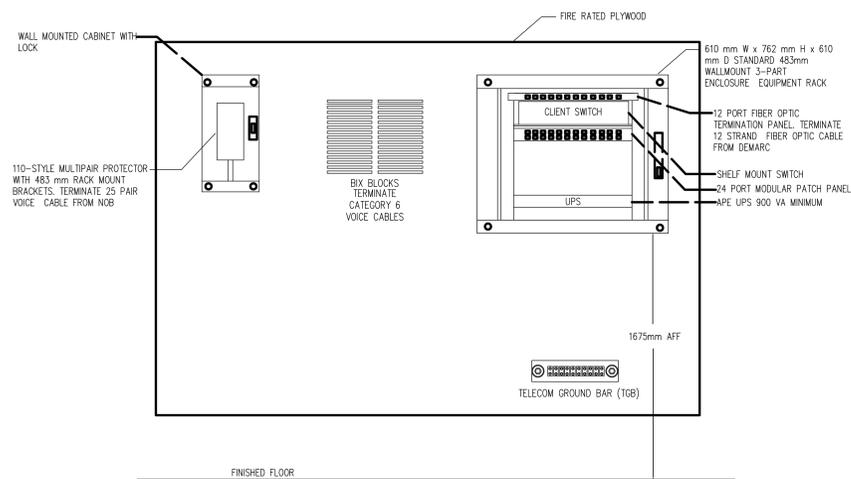


2 WALL ELEVATION - ANCILLARY BUILDINGS  
ET503 NTS

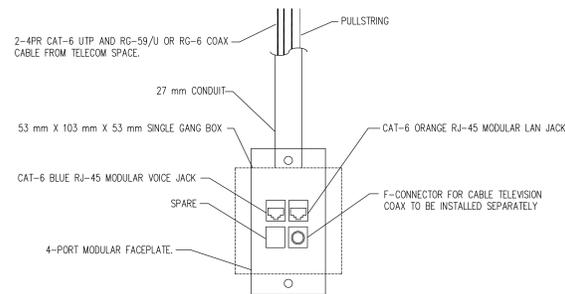


3 TYPICAL COMBINATION OUTLET  
ET503 NTS

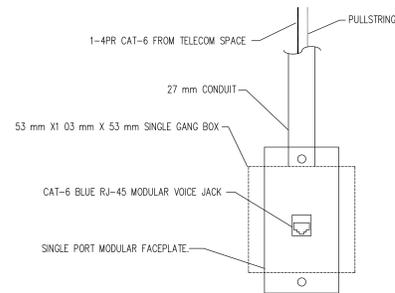


4 TYPICAL VOICE ONLY OUTLET  
ET503 NTS

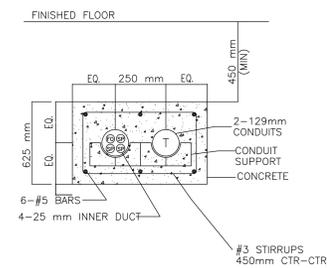


5 DUCTBANK DETAIL - ANCILLARY BUILDINGS  
ET503 NTS

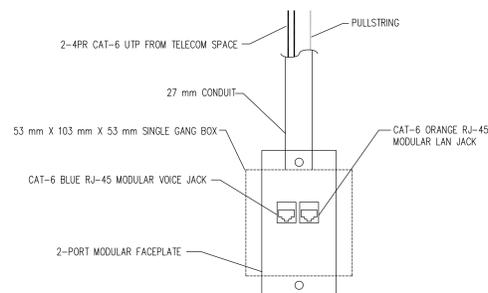

6 TYPICAL VOICE AND DATA OUTLET  
ET503 NTS

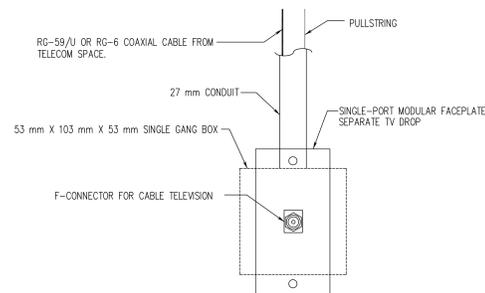

7 TYPICAL AUDIO/VISUAL OUTLET  
ET503 NTS

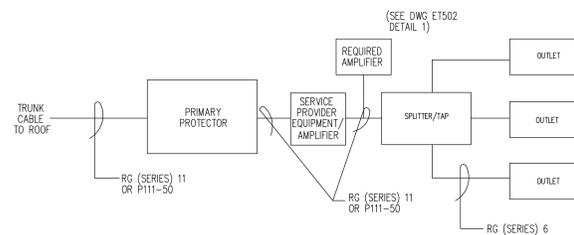

8 CONNECTIVITY DIAGRAM - SATELLITE TELEVISION  
ET503 NTS

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## Barracks 101

### Building Information Model Common File

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#### CODED NOTES

- 1 8 PIN PLUG PER EIA TIA-568A.

#### NOTE:

1. PROVIDE BALLISTIC PROTECTION AT ALL PIPES AND CONDUITS PENETRATING THE FEER ENVELOPE OF THE BUILDING. SEE NOB DRAWINGS FOR TYPICAL DETAILS.


Rev. Number	Description	Date
Revisions		

#### TELECOM DETAILS


DBO Project Number	Drawing Scale	Phase
AS NOTED	AS NOTED	AS NOTED
CAO File Name	CAO Plot Scale	CAO Plot Scale
CBMET503.DWG	1:1	1:1
Date	NOV-2012	Sheet Number
Drawn By	NIBS/bsd	Barracks ET503
Checked By	NIBS/bsd	
Project Number		Classification
		UNCLASSIFIED

FURNITURE AND EQUIPMENT SCHEDULE						
MODEL	DESCRIPTION	OFCI	OFOI	CFCI	SPECIFICATIONS NUMBER	NOTES
EX.1	EXERCISE EQUIPMENT, TREADMILL	No	Yes	No	-	-
EX.2	EXERCISE EQUIPMENT, ELLIPTICAL	No	Yes	No	-	-
EX.3	EXERCISE EQUIPMENT, STAIRCLIMBER	No	Yes	No	-	-
EX.4	EXERCISE EQUIPMENT, EXERCISE BIKE	No	Yes	No	-	-
EX.5	EXERCISE EQUIPMENT, 3 STACK MULTI-GYM UNIVERSAL MACHINE	No	Yes	No	-	-
EX.6	EXERCISE EQUIPMENT, DUMBBELL RACK	No	Yes	No	-	-
EX.7	EXERCISE EQUIPMENT, BENCH	No	Yes	No	-	-
KT.2	MICROWAVE, COUNTERTOP	No	No	Yes	113105	-
KT.4	WASHER	No	No	Yes	113105	-
KT.5	DRYER	No	No	Yes	113105	-
KT.7	FULL SIZE ICE MAKER	No	No	Yes	113105	-
KT.9	UNDERCOUNTER REFRIGERATOR	No	No	Yes	113105	-
KT.10	OVEN RANGE	No	No	Yes	113105	-
KT.11	RANGE HOOD	No	No	Yes	113105	-
KT.12	UNDERCOUNTER DISHWASHER	No	No	Yes	113105	-
KT.15	REFRIGERATOR, RESIDENTIAL	No	No	Yes	113105	-
KT.16	FREEZER	No	No	Yes	113105	-
KT.17	REFRIGERATOR, COMMERCIAL	No	No	Yes	113105	-
MQ.1	POOL TABLE	No	Yes	No	-	-
MQ.2	BARRACKS WARDROBE	Yes	No	No	-	-
MQ.3	BARRACKS DESK (INCLUDES CHAIR & DESK LAMP)	Yes	No	No	-	-
MQ.4	BARRACKS DRESSER & CHEST OF DRAWERS	Yes	No	No	-	-
MQ.5	BARRACKS BED (INCLUDES MATTRESS, BOX SPRING, BED FRAME, PILLOWS, & BEDSPREAD)	Yes	No	No	-	-
MQ.6	BARRACKS NIGHT STAND (INCLUDES TABLE LAMP)	Yes	No	No	-	-
MQ.7	STOOL	Yes	No	No	-	-
MQ.11	CREDENZA	Yes	No	No	-	-
MQ.12	NIGHT STAND LAMP	Yes	No	No	-	-
MQ.13	TABLE LAMP	Yes	No	No	-	-
MQ.14	SOFA	Yes	No	No	-	-
MQ.15	MODULAR SHELVING, HEAVY DUTY STEEL 36"W X 12"D X 84"H	No	No	Yes	105613	-
MQ.16	MODULAR SHELVING, HEAVY DUTY STEEL 36"W X 18"D X 84"H	No	No	Yes	105613	-
MQ.17	MODULAR SHELVING, HEAVY DUTY STEEL 30"W X 18"D X 84"H	No	No	Yes	105613	-
MQ.18	END TABLE	Yes	No	No	-	-
MQ.19	CHINA CABINET	Yes	No	No	-	-
MQ.20	TELEVISION, FLAT SCREEN, WALL MOUNTED	No	Yes	No	-	COORDINATE WITH MIRROR PLACEMENT
MQ.21	WALL-TO-WALL MIRRORS	No	No	Yes	102800	HEIGHT: FROM ABOVE WALL BASE TO SAME HEIGHT AS DOORS
MQ.22	DINING CHAIR	Yes	No	No	-	-
MQ.23	ARM CHAIR	Yes	No	No	-	-
MQ.24	LOUNGE CHAIR	Yes	No	No	-	-
MQ.26	DINING TABLE	Yes	No	No	-	-
MQ.27	COFFEE TABLE	Yes	No	No	-	-
MQ.28	BOOKCASE	Yes	No	No	-	-
MQ.29	DINING TABLE W/4 ARM CHAIRS	Yes	No	No	-	-
MQ.30	BARSTOOL	Yes	No	No	-	-
MQ.31	COUNTER HEIGHT STOOL	Yes	No	No	-	-
MQ.32	EXTERIOR CHAIRS (4 PER TABLE)	Yes	No	No	-	-
MQ.33	EXTERIOR TABLE W/ UMBRELLA	Yes	No	No	-	-
MQ.34	BLACKOUT SHADE	No	No	Yes	122415	COMMERCIAL GRADE FABRIC, INCLUDE DRAW ROD.
MQ.35	SIDEBOARD	Yes	No	No	-	-
MQ.36	FULL HEIGHT LOCKERS	Yes	No	No	-	-


EQUIPMENT SCHEDULE						
MODEL	DESCRIPTION	GFCI	GFGI	CFCI	NOTES	SPECIFICATION NUMBER
TA-2	SEAT COVER DISPENSER	No	No	Yes	-	102800
TA-3	TOWEL DISPENSER / WASTE RECEPTACLE	No	No	Yes	-	102800
TA-6	-	-	-	-	-	102800
TA-8	TOILET TISSUE DISPENSER SURFACE MOUNTED	No	No	Yes	-	102800
TA-11	COAT HOOK (LOCATE 1 EACH PER RESTROOM DOOR & @ BAR, BELOW COUNTER @ STOOL)	No	No	Yes	-	102800
TA-12	TOWEL BAR	No	No	Yes	-	102800
TA-20	FRAMED MIRROR	No	No	Yes	-	102800
TA-21	FULL LENGTH MIRROR	No	No	Yes	-	102800
TA-24	RECESSED MEDICINE CABINET	No	No	Yes	-	102800
TA-30	SOAP DISH, RECESSED	No	No	Yes	-	102800
TA-31	TOOTH BRUSH HOLDER	No	No	Yes	-	102800
TA-33	WALL MOUNT SOAP DISPENSER	No	No	Yes	-	102800
TA-40	TOILET GRAB BARS	No	No	Yes	-	102800

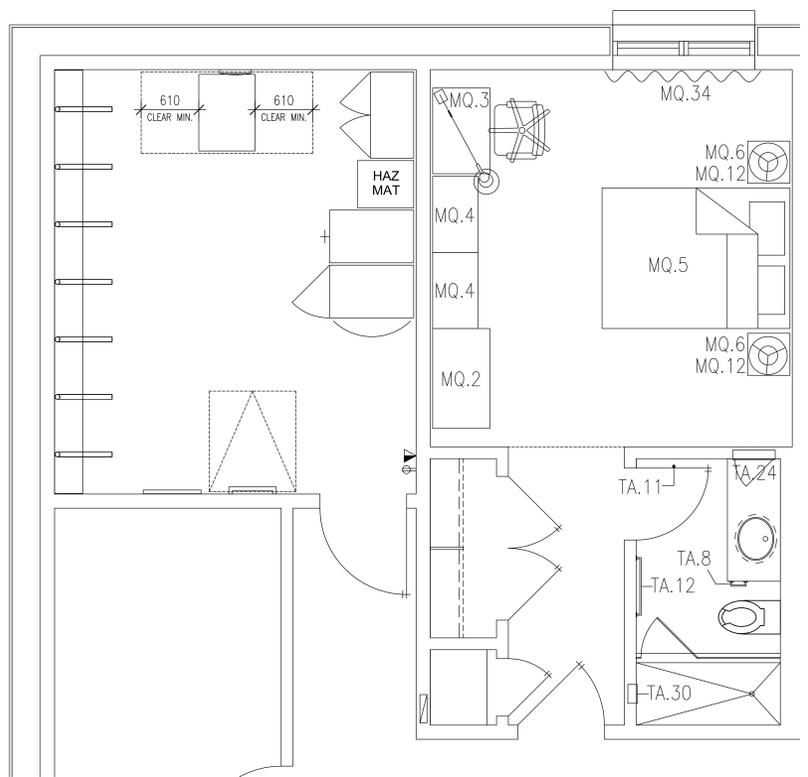

2 LEVEL TWO FURNITURE PLAN  
A111 1:25

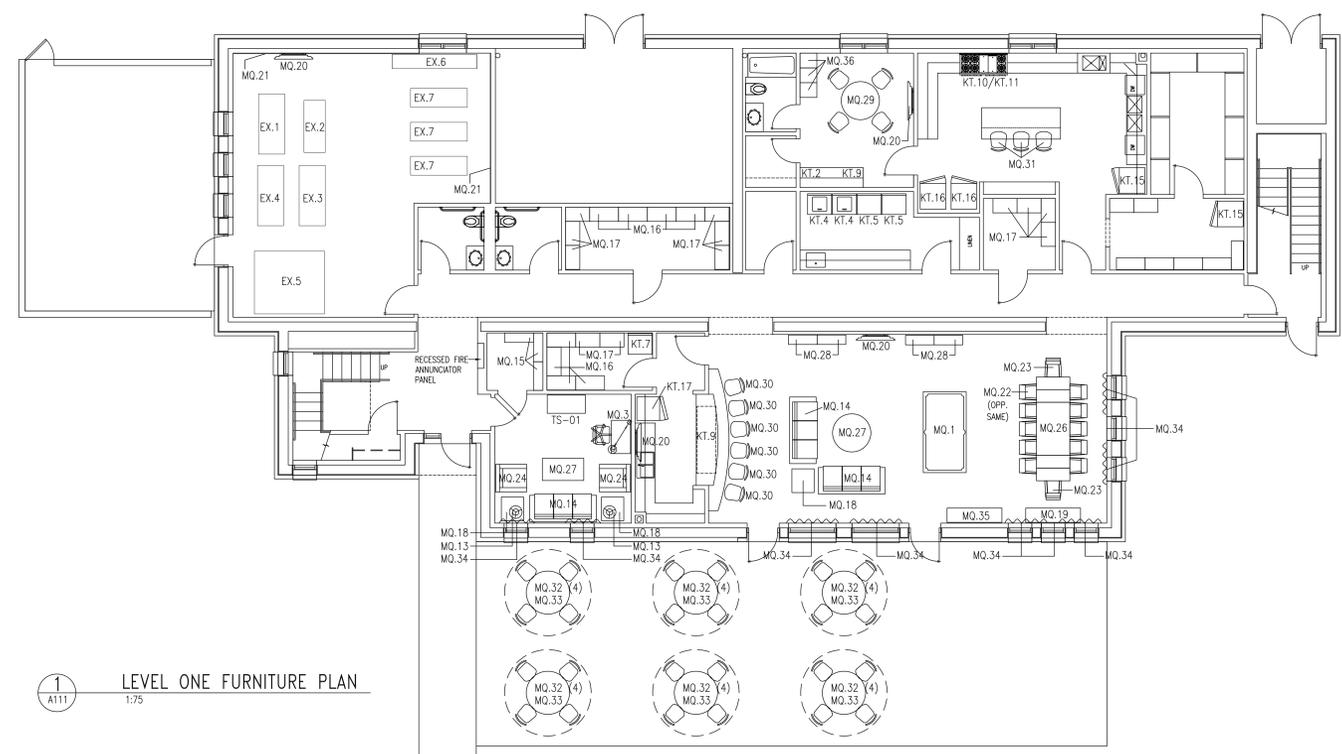

1 LEVEL ONE FURNITURE PLAN  
A111 1:75

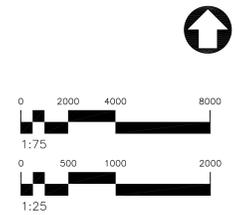

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## Barracks 101

### Building Information Model Common File

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Rev. Number	Description	Date
Revisions		

Release For Construction:  
NIBS/Asa

## FURNITURE PLANS

DBO Project Number	Drawing Scale	Phase
CBMFF111.DWG	1:25	AS NOTED
CAD File Name	CAD File Scale	CONCEPT <input type="checkbox"/> ITR <input type="checkbox"/> REV <input type="checkbox"/> M&M <input type="checkbox"/>
Project Number	Date	Sheet Number
	NOV-2012	Barracks FF111
Drawn By	Checked By	Classification
NIBS	NIBS	UNCLASSIFIED




**Barracks 101**  
Building Information Model  
Common File


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- GENERAL NOTES FOR DESIGNER:**
- DESIGN MECHANICAL SYSTEMS PER THE LATEST VERSION OF THE INTERNATIONAL MECHANICAL CODE (IMC) AND OBO DESIGN REQUIREMENTS AND SPECIFICATIONS.
  - EQUIPMENT, DUCTWORK, AND PIPING SIZES AND LOCATIONS ARE SCHEMATIC IN NATURE. ACTUAL SIZES AND LOCATIONS ARE TO BE BASED ON SITE-SPECIFIC CONDITIONS AND OBO DESIGN STANDARDS AND SPECIFICATIONS.
  - EQUIPMENT, DUCTWORK, & PIPING SYSTEMS SHOWN ON DRAWINGS DOES NOT REFLECT THE ENTIRETY OF SYSTEMS REQUIRED FOR BUILDING. ADDITIONAL SYSTEMS REQUIRED TO BE BASED ON SITE-SPECIFIC REQUIREMENTS, OBO DESIGN REQUIREMENTS, AND OBO SPECIFICATIONS.
  - DESIGN AIR SYSTEMS TO SOUND LEVELS FOR SPECIFIC SPACE TYPES AS DEFINED BY 2003 ASHRAE APPLICATIONS HANDBOOK, CHAPTER 47.
  - SIZE RELIEF AIR EXHAUST FAN PER SITE-SPECIFIC REQUIREMENTS AND TO MAINTAIN PROPER PRESSURE DIFFERENTIALS AND SPACE CONDITIONS.
  - A/E MAY ALTER BAR & RECREATION ROOM AIR DISTRIBUTION TO ENRICH ROOM APPEARANCE.


- KEYED NOTES:**
- PROVIDE MECHANICAL COOLING OR VENTILATION TO MAINTAIN SPACE TEMPERATURE/HUMIDITY WITHIN EQUIPMENT REQUIREMENTS.

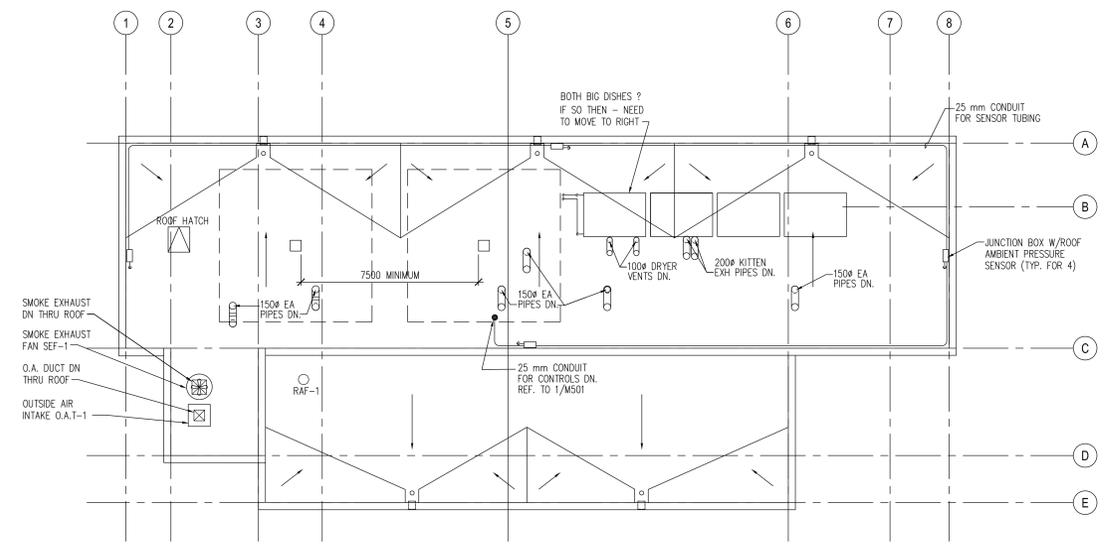


**3 ROOF PLAN**  
M111 1:100

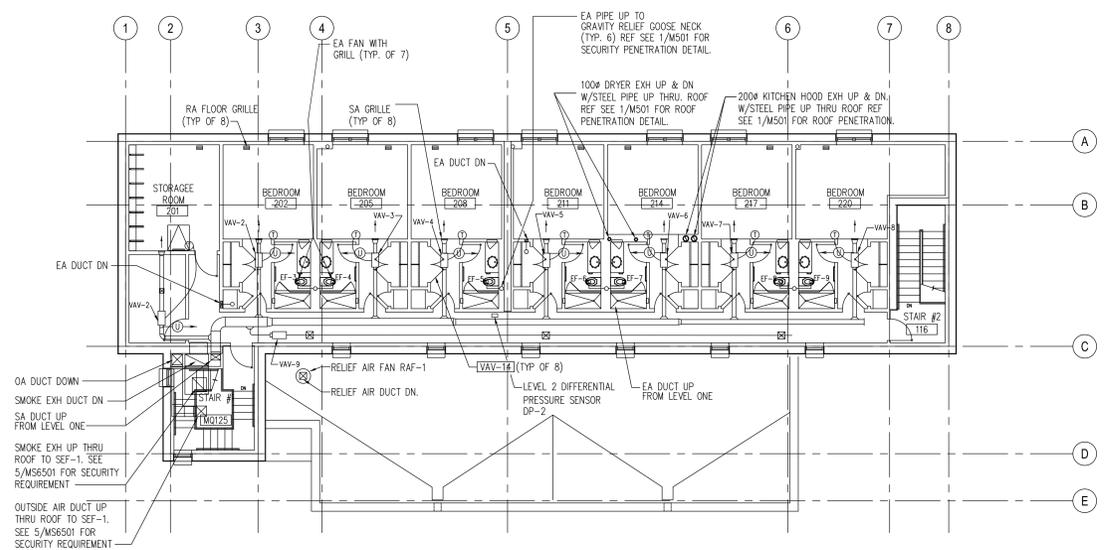

**2 LEVEL TWO FLOOR PLAN**  
M111 1:100

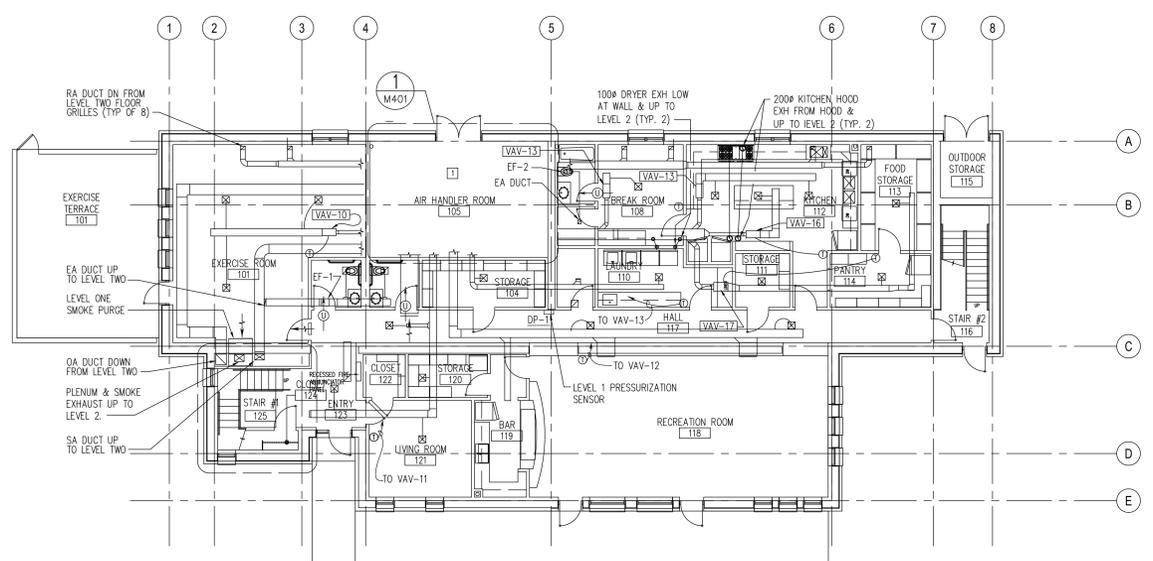

**1 LEVEL ONE FLOOR PLAN**  
M111 1:100

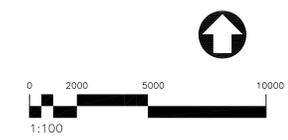

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Rev. Number	Description	Date

Release For Construction:  NIB/AS


Drawing Title: **FLOOR PLAN**

OBO Project Number:  AS NOTED  OBO  
 CAD File Name: CBMM111.DWG  
 OBO Plot Scale:  CONCEPT  1/4"  1/8"  1/2"  1"  1:1

Date: NOV-2012  
 Drawn By: NIBS  
 Checked By: NIBS  
 Project Number: **Barracks M111**  
 Classification: UNCLASSIFIED

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1 ENLARGED AIR HANDLER ROOM PLAN  
M401 1:50

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Building Information Model  
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  - DESIGN AIR SYSTEMS TO SOUND LEVELS FOR SPECIFIC SPACE TYPES AS DEFINED BY 2003 ASHRAE APPLICATIONS HANDBOOK, CHAPTER 47.
  - SIZE AND LOCATE EXHAUST FANS PER SITE-SPECIFIC REQUIREMENTS AND TO MAINTAIN PROPER PRESSURE DIFFERENTIALS AND SPACE CONDITIONS.

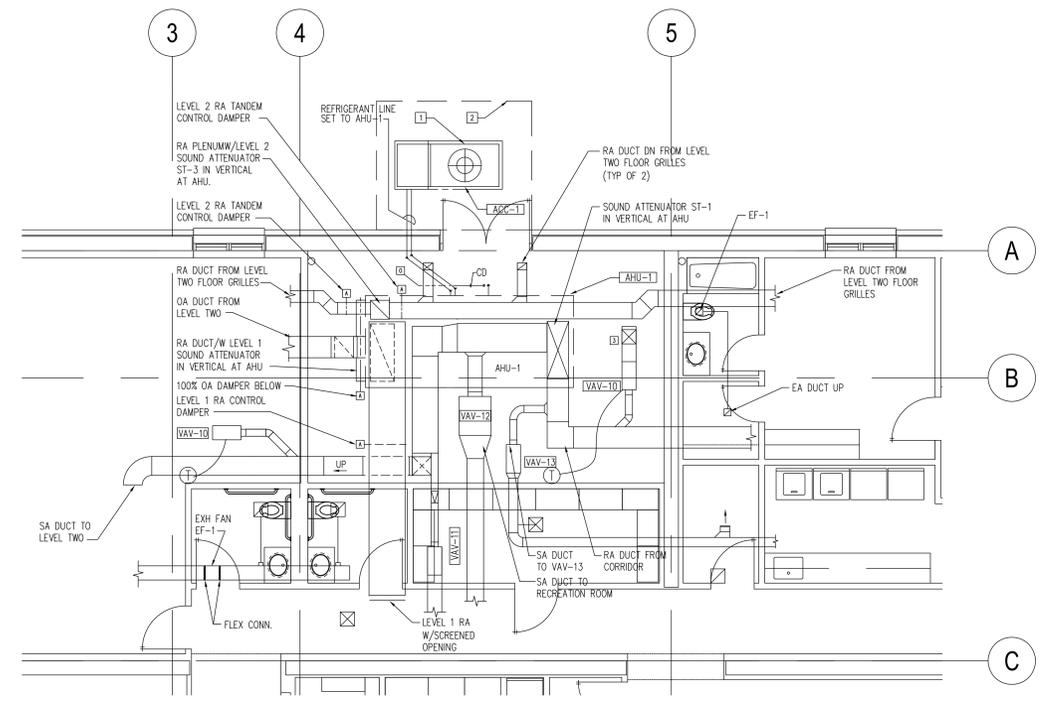
- KEYED NOTES:**
- CONDENSING UNIT ON CONCRETE HOUSEKEEPING PAD SHALL BE LOCATED ON A SITE-SPECIFIC BASIS WITHIN THE COMPOUND BOUNDARY.
  - MAINTENANCE CLEARANCE.
  - PROVIDE MECHANICAL COOLING OR VENTILATION TO MAINTAIN SPACE TEMPERATURE/HUMIDITY WITHIN EQUIPMENT REQUIREMENTS.

Rev. Number	Description	Date
Revisions		

Release For Construction:  NIB/AS

Drawing Title: **ENLARGED AIR HANDLER ROOM PLAN**

OBO Project Number	Drawing Scale	Phase
AS NOTED	AS NOTED	CONCEPT
CAD File Name: CBMM401.DWG	CAD Plot Scale: 1:1	DATE
		NOV-2012
Drawn By: NIBS	Checked By: NIBS	Project Number: <b>Barracks M401</b>
Classification: UNCLASSIFIED		

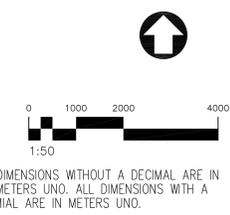

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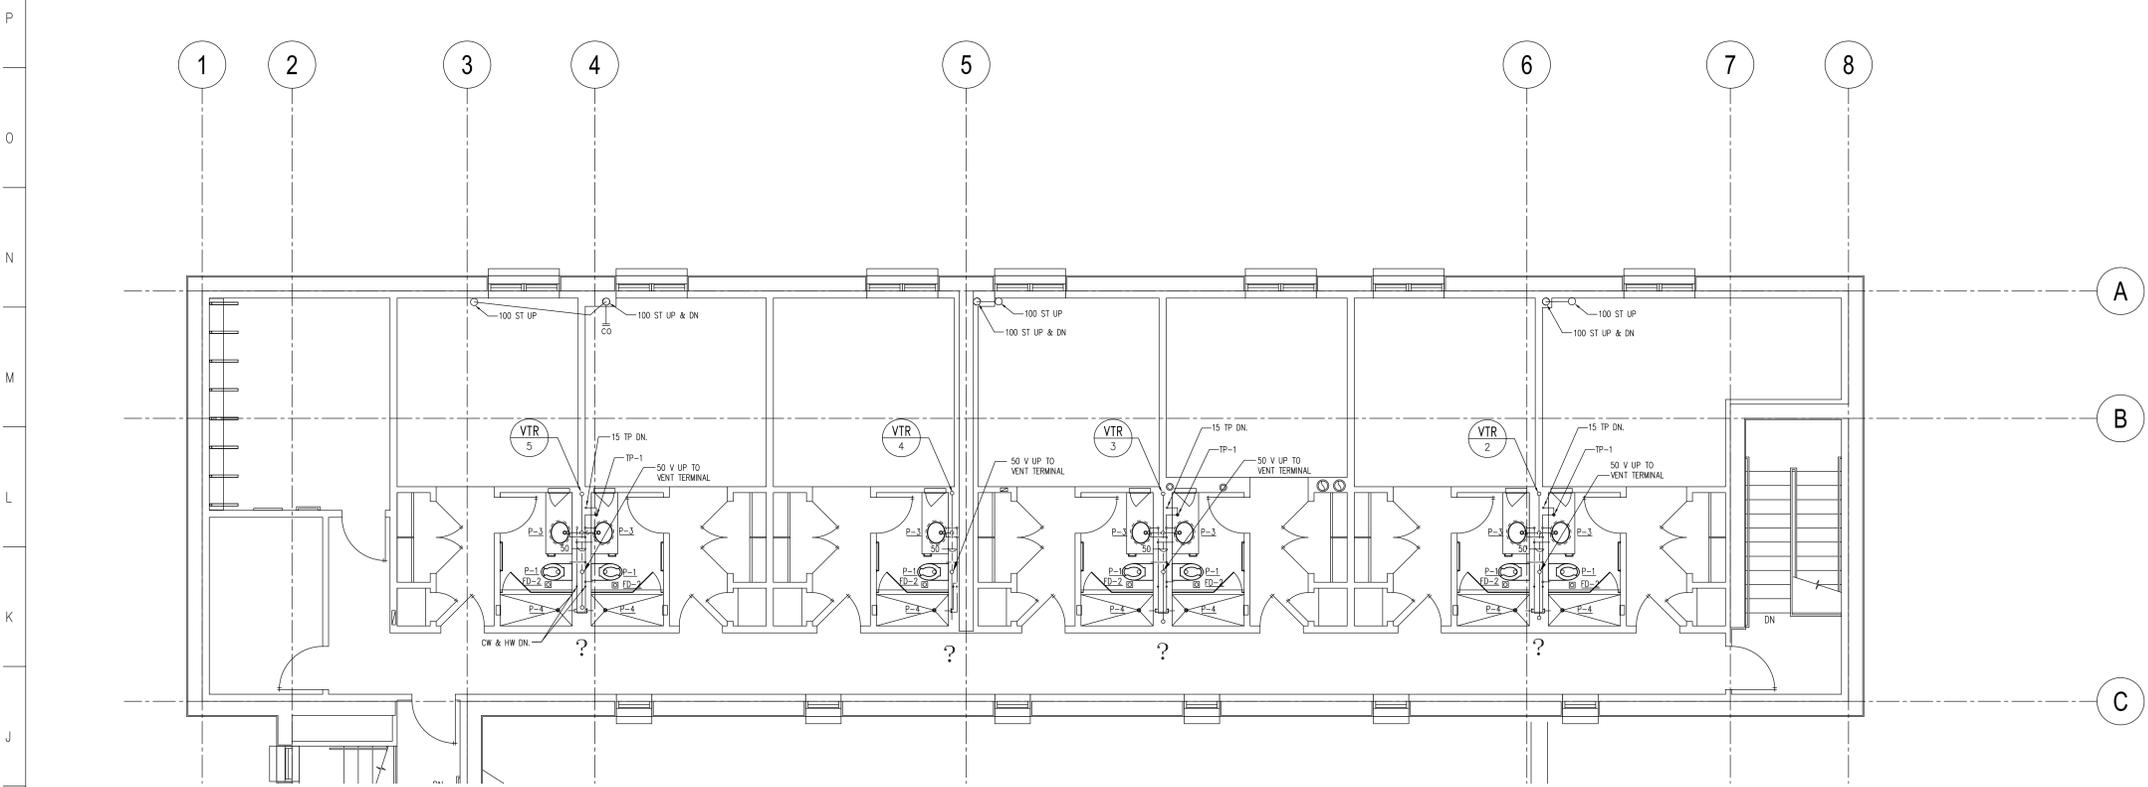









1 2 3 4 5 6 7 8 9 10 11 12 13 14 15 16 17 18



1 ENLARGED LEVEL TWO FLOOR PLAN  
P401 1:50

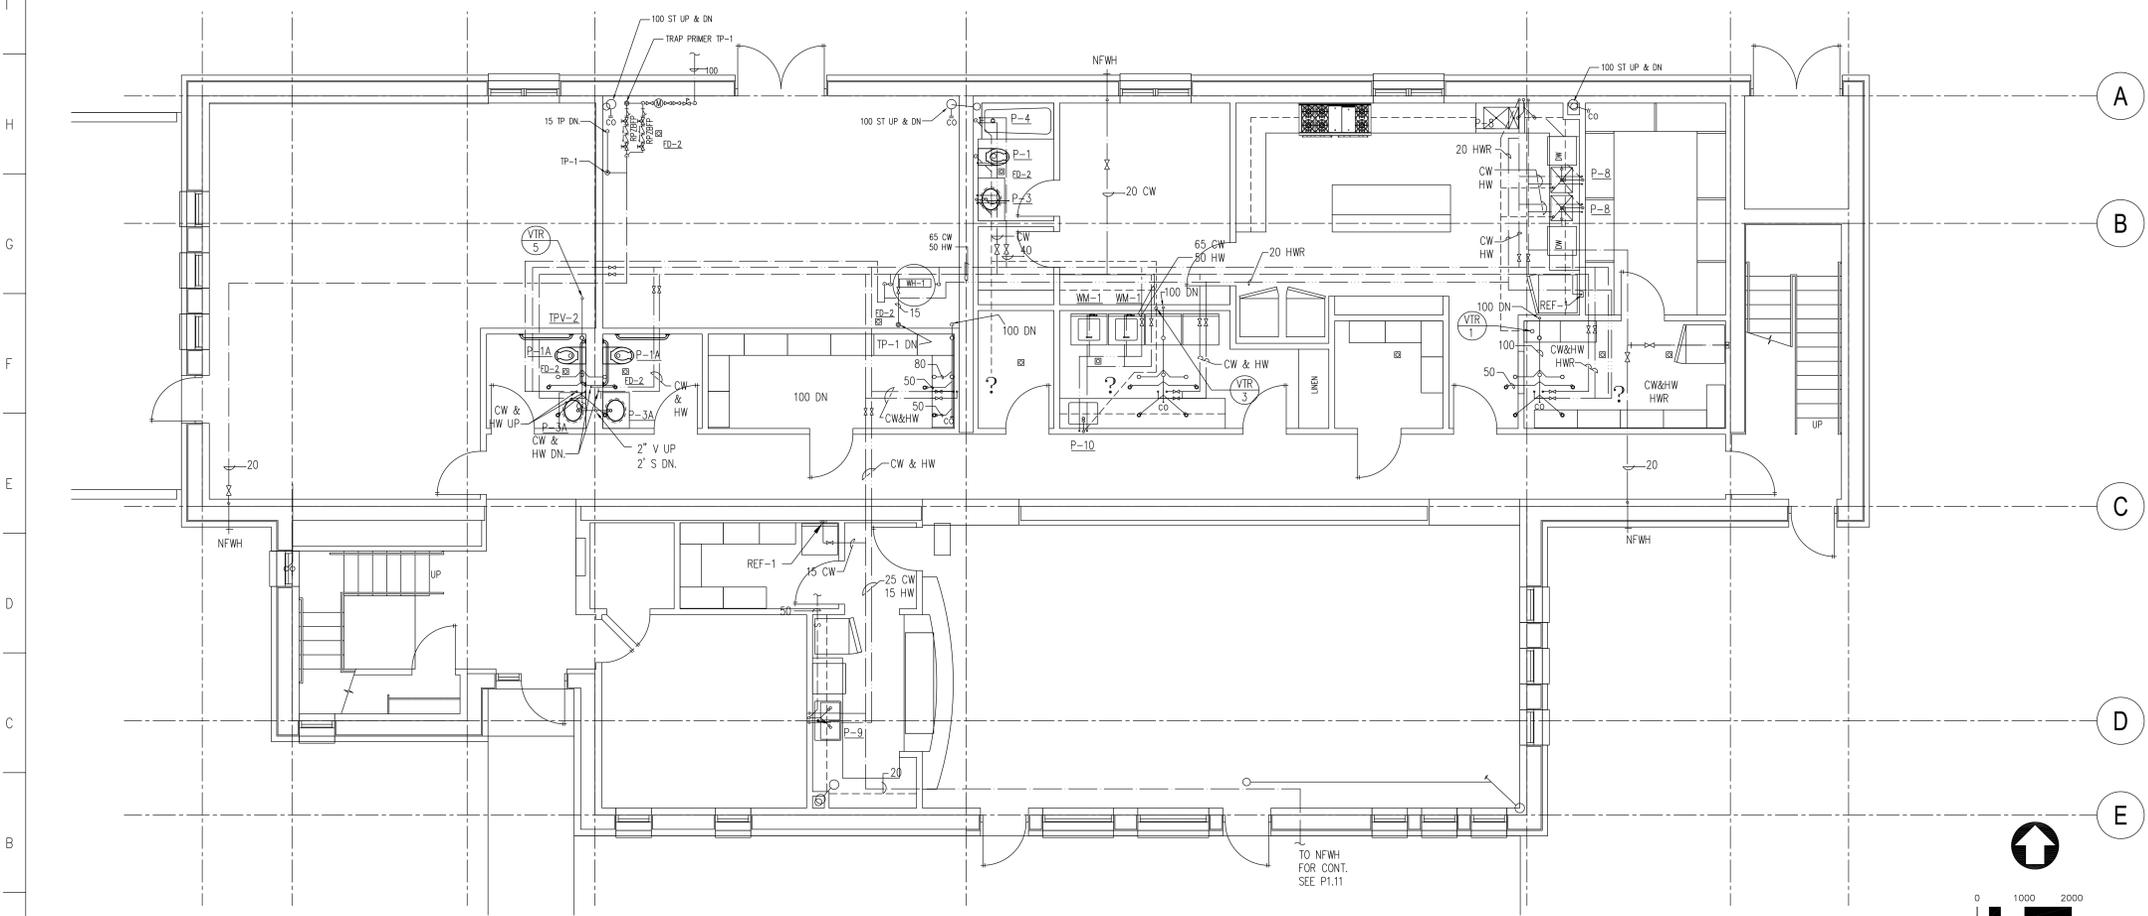

2 ENLARGED LEVEL ONE FLOOR PLAN  
P401 1:50

1 2 3 4 5 6 7 8 9 10 11 12 13 14 15 16 17 18

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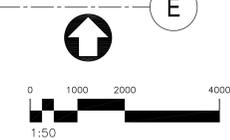
- GENERAL NOTES:**
- DESIGN PLUMBING SYSTEMS PER THE LATEST VERSION OF THE INTERNATIONAL PLUMBING CODE (IPC) AND OWNER DESIGN REQUIREMENTS AND SPECIFICATIONS.
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Rev. Number	Description	Date
Revisions		

Release For Construction:  
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**ENLARGED PLANS**

DBO Project Number	Drawing Scale	Phase
AS NOTED	1:50	SCHEMATIC
CAD File Name	CAD Plot Scale	CONVERT
CBMP401.DWG	1:1	<input type="checkbox"/> 1/8" <input type="checkbox"/> 1/4" <input type="checkbox"/> 3/8" <input type="checkbox"/> 1/2" <input type="checkbox"/> 3/4" <input type="checkbox"/> 1" <input type="checkbox"/> 1 1/2" <input type="checkbox"/> 2" <input type="checkbox"/> 3" <input type="checkbox"/> 4" <input type="checkbox"/> 6" <input type="checkbox"/> 8" <input type="checkbox"/> 12" <input type="checkbox"/> 18" <input type="checkbox"/> 24"
Date	NOV-2012	Sheet Number
Drawn By	NIBS	<b>Barracks</b> <b>P401</b>
Checked By	NIBS	
Project Number		Classification
		UNCLASSIFIED



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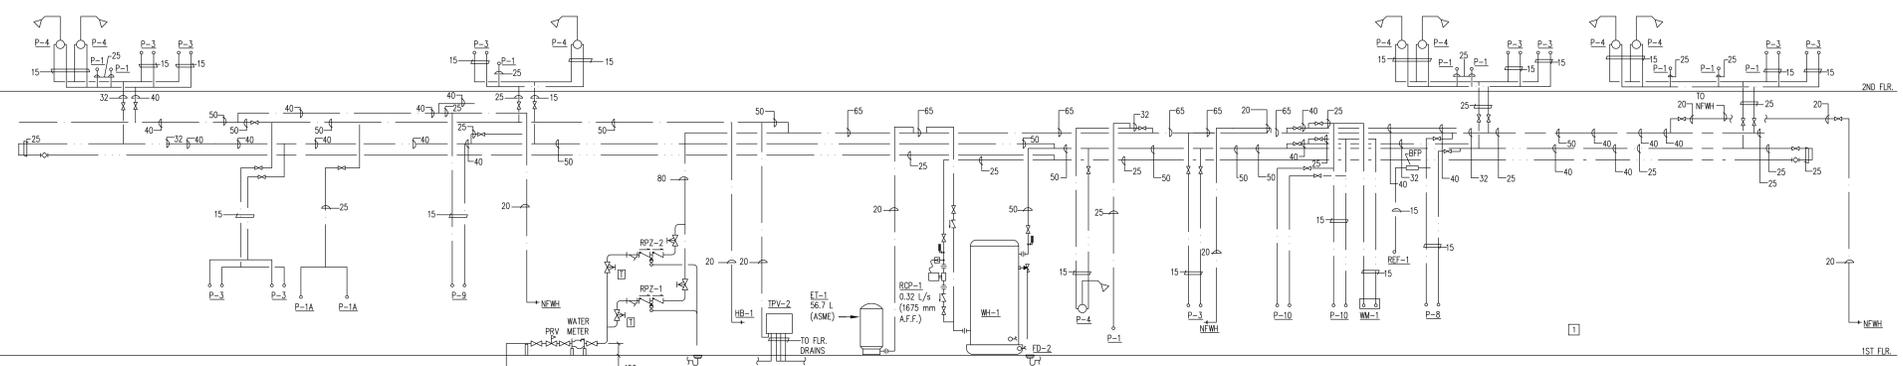
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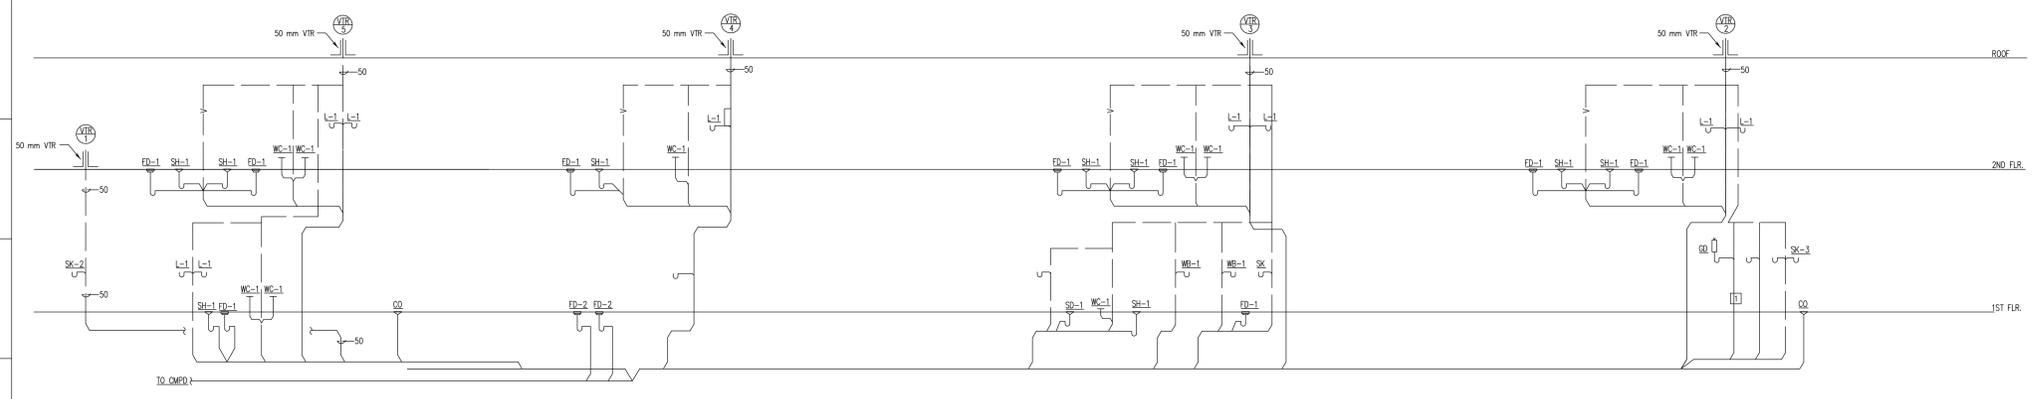
**KEYED NOTES:**

PLUMBING RISER DIAGRAMS ARE SITE-SPECIFIC. GENERATE DIAGRAMS FOR EVERY APPLICATION OF THE STANDARD DESIGN. DIAGRAMS CANNOT BE USED "AS-IS" AND MUST BE ADJUSTED TO REPRESENT THE SITE-SPECIFIC PLUMBING DESIGN. THE DIAGRAMS HAVE BEEN INCLUDED TO ILLUSTRATE THE MINIMUM ACCEPTABLE LEVEL OF DETAIL REQUIRED.


PROVIDE WATER METER WIRE TO THE BAS.



**1 DOMESTIC WATER RISER DIAGRAM**  
1:100



**2 SANITARY DRAINAGE DIAGRAM**  
1:100

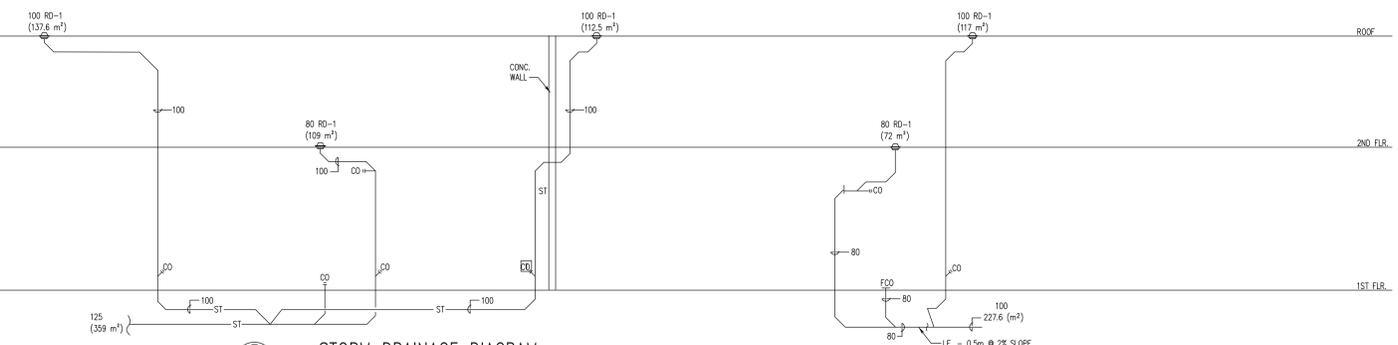

**3 STORM DRAINAGE DIAGRAM**  
1:100

Rev. Number	Description	Date
Revisions		

Release For Construction: NIBS/Asa

Drawing Title: **RISER DIAGRAMS**

DBO Project Number: CBMP511.DWG  
 Drawing Scale: 1:1  
 Date: NOV-2012  
 Sheet Number: 1 of 1


Drawn By: NIBS  
 Checked By: NIBS  
 Project Number: **P511**  
 Classification: UNCLASSIFIED



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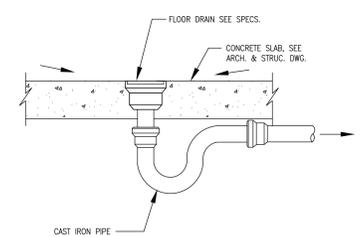
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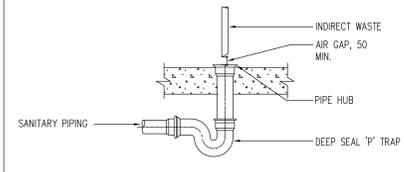
**NOTES:**  
1. REFER TO ARCHITECTURE DRAWINGS FOR EXACT CONSTRUCTION CONDITIONS AND REQUIREMENTS.

1 FLOOR SINK DETAIL  
P521 NTS

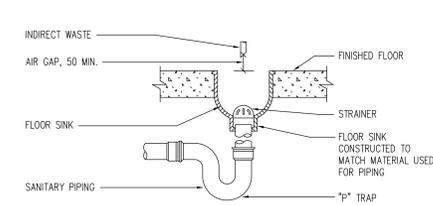


**NOTES:**  
1. REFER TO ARCHITECTURE DRAWINGS FOR EXACT CONSTRUCTION CONDITIONS AND REQUIREMENTS.

2 FLOOR DRAIN DETAIL  
P521 NTS




**NOTES:**  
1. REFER TO ARCHITECTURE DRAWINGS FOR EXACT CONSTRUCTION CONDITIONS AND REQUIREMENTS.


3 OPEN SITE DRAIN DETAIL  
P521 NTS

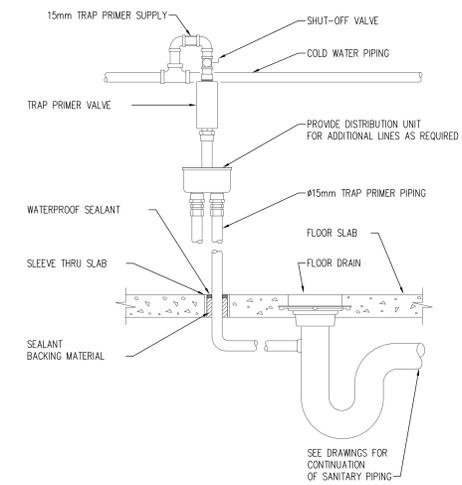


4 TRAP PRIMER TP-1 DETAIL  
P521 NTS

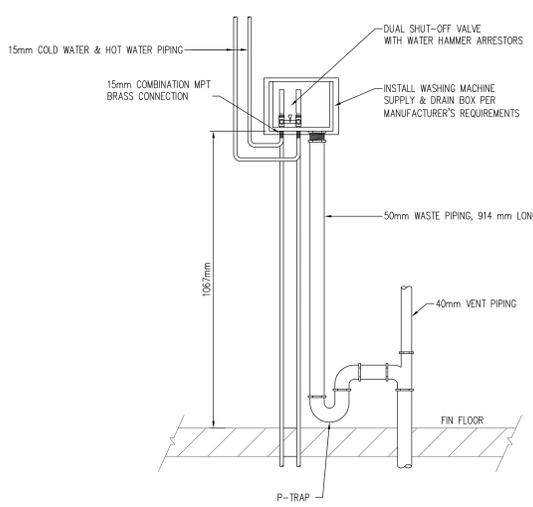



5 WASHING MACHINE SUPPLY & DRAIN WB-1  
P521 NTS

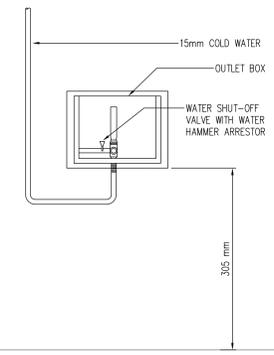


6 REFRIGERATOR OUTLET BOX REF-1  
P521 NTS

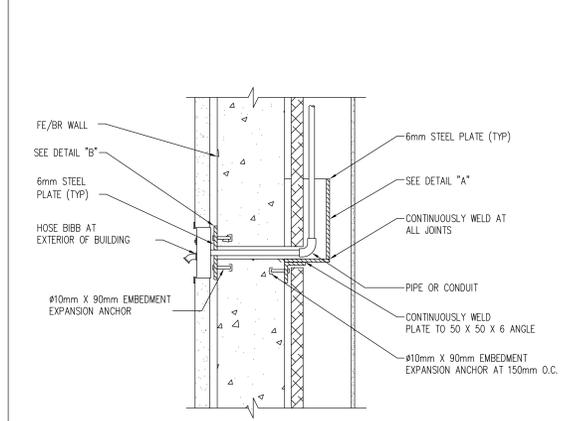


7 HOSE BIBB PENETRATION DETAIL  
P521 NTS

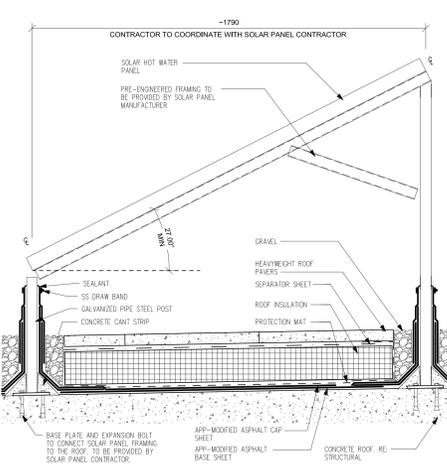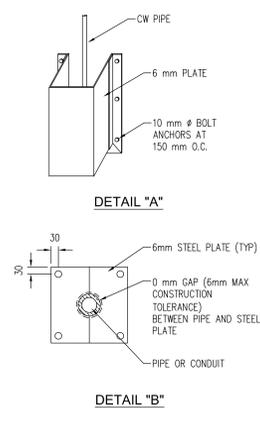


8 DETAIL OF SOLAR HOT WATER PANELS  
P521 NTS

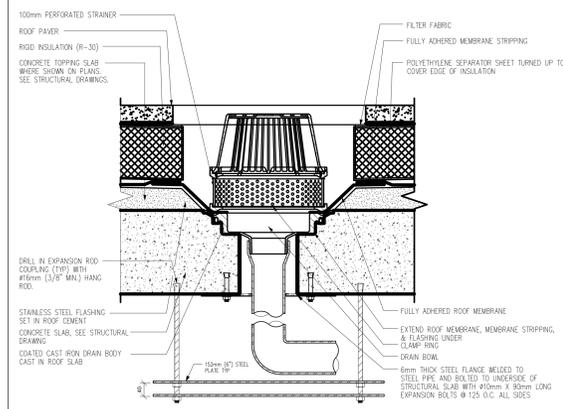

9 TYP ROOF DRAIN DETAIL  
P521 NTS

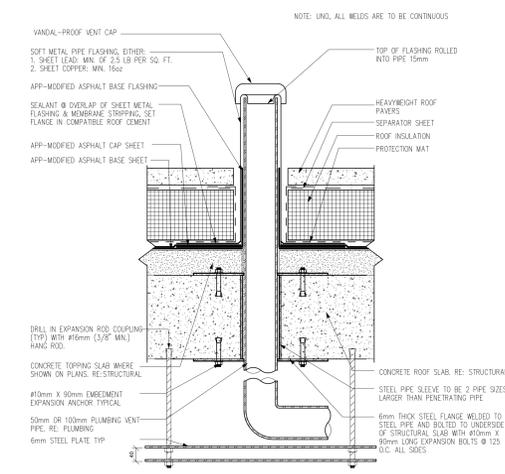

10 TYP PIPE PENETRATION DETAIL  
P521 NTS

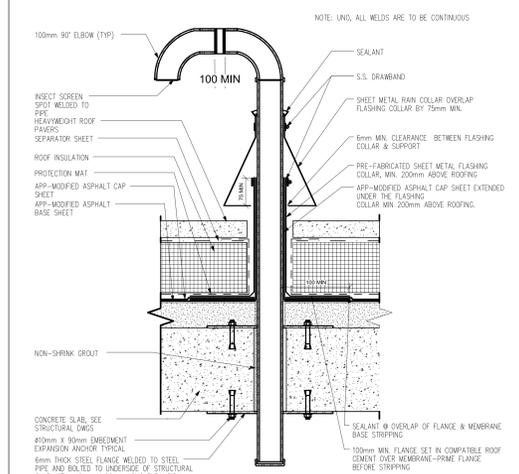

11 TYP GOOSENECT PIPE PENETRATION DETAIL  
P521 NTS

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**NOTE:**  
1. PROVIDE BALLISTIC PROTECTION AT ALL PIPES AND CONDUITS PENETRATING THE FBFR ENVELOPE OF THE BUILDING. SEE NOB DRAWINGS FOR TYPICAL DETAILS.

Rev. Number	Description	Date

Release For Construction:  
NIB/Asa

**DETAILS**

DBO Project Number: CBMP521.DWG  
Drawing Scale: AS NOTED  
Phase: 04  
CAO File Name: CBMP521.DWG  
CAO Plot Scale: 1:1  
Date: JAN-2012  
Sheet Number: 11  
Drawn By: NIBS  
Checked By: NIBS  
Project Number: Barracks 101  
Classification: UNCLASSIFIED

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PLUMBING FIXTURE SCHEDULE						
TAG	NAME	WASTE	VENT	COLD WATER	HOT WATER	REMARKS
P-1	WATER CLOSET	100	50	25	-	TANK TYPE (MOUNTED 457 mm TOP OF SEAT)
P-1A	WATER CLOSET (HC)	100	50	25	-	TANK TYPE (MOUNTED 457 mm TOP OF SEAT)
P-2	URINAL	50	40	20	-	
P-3	LAVATORY	40	40	15	15	
P-4	-	40	40	15	15	
N/A						
P-6	SHOWER	50	40	15	15	
N/A P-7	SERVICE SINK	80	40	15	15	
P-8	SINK (KITCHEN)	40	40	15	15	
P-9	BAR SINK	40	40	15	15	
P-10	LAUNDRY SINK	80	40	15	15	
P-11	SINK	40	40	15	15	
REF-1	REFRIGERATOR OUTLET BOX	-	-	15	-	
HB-1	HOSE BIB	-	-	15	-	
HB-2	HOSE BIB W/ ENCLOSURE	-	-	15	-	
NFMH	NON-FREEZE WALL HYDRANT	-	-	15	-	BALLISTIC PROOF
WM-1	WASHING MACHINE (SUPPLY/DRAIN BOX)	80	40	15	15	
TPV-1	TRAP PRIMER VALVE	-	-	15	-	
FD-1	FLOOR DRAIN	80	40	-	-	
FD-2	FLOOR DRAIN	80	40	-	-	
EFD-1	EMERGENCY FLOOR DRAIN	80	40	-	-	
OB						

**NOTES**  
 1. ELECTRICAL CHARACTERISTICS SHALL BE MODIFIED, AS NEEDED TO ENSURE FULLY AND PROPERLY FUNCTIONING SYSTEMS AND COMPONENTS, TO MATCH HOST COUNTRY'S STANDARD ELECTRICAL CURRENT TYPE, FREQUENCY, NUMBER OF PHASES, AND NOMINAL VOLTAGE.

DOMESTIC WATER HEATER SYSTEM SCHEDULE (OPTIDN)										
TAG	TYPE	LOCATION	CAPACITY (LITERS)	ELECTRIC			RECOVERY RATE		MANUFACTURER AND MODEL	REMARKS
				VOLT	PH	HZ	L/H	TEMP. RISE (°C)		
WH-1	TANK-TYPE STORAGE		-	-	-	50	-	-	-	ELECTRIC, NATURAL GAS-FIRED, AND OIL-FIRED HEATERS TO BE EVALUATED BASED ON SITE CONDITIONS AND LIFE CYCLE COST COMPARISON.
ET-1	EXPANSION TANK	FIRST FLOOR MECHANICAL RM.	-	-	-	-	-	-	-	

**NOTES**  
 1. ELECTRICAL CHARACTERISTICS SHALL BE MODIFIED, AS NEEDED TO ENSURE FULLY AND PROPERLY FUNCTIONING SYSTEMS AND COMPONENTS, TO MATCH HOST COUNTRY'S STANDARD ELECTRICAL CURRENT TYPE, FREQUENCY, NUMBER OF PHASES, AND NOMINAL VOLTAGE.  
 2. SIZE AND SELECT EQUIPMENT BASED ON SITE-SPECIFIC CONDITIONS AND OBO REQUIREMENTS.

SOLAR WATER HEATER SCHEDULE (OPTIDN)									
TAG	TYPE	CAPACITY (LITERS)	ELECTRIC			RECOVERY RATE		MANUFACTURER AND MODEL	REMARKS
			VOLT	PH	HZ	L/H	TEMP. RISE (°C)		
SWH	SOLAR WATER HEATER	-	-	-	-	-	32'	-	LOCATED IN 1ST FLOOR MECHANICAL ROOM WITH ELECTRIC BACK-UP
ET-1	EXPANSION TANK	-	-	-	-	-	-	-	LOCATED IN 1ST FLOOR MECHANICAL ROOM 11.7 L ACCEPTANCE VOLUME

DOMESTIC WATER CIRCULATING PUMP SCHEDULE								
TAG	L/s	TDH (ft)	MOTOR HP	ELECTRICAL			MANUFACTURER AND MODEL	REMARKS
				VOLTS	PH	HZ		
DCP-1	-	-	-	-	-	50		

WATER HAMMER ARRESTER SCHEDULE						
P.D.L UNIT RATING	A	B	C	D	E	F
FIXTURE UNIT CAPACITY	1-11	12-32	33-60	61-113	114-154	155-330

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**GENERAL NOTES:**  
 1. DESIGN PLUMBING SYSTEMS PER THE LATEST VERSION OF THE INTERNATIONAL PLUMBING CODE (IPC) AND OWNER DESIGN REQUIREMENTS AND SPECIFICATIONS.

Rev. Number	Description	Date

Release For Construction:  
 NIBS/Asa NIBS/Asa


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**SCHEDULES**

OBO Project Number Drawing Scope Phase AS NOTED O&M  
 CAD File Name CAD Plot Scale 1:1  
 CBMP601.DWG


Date NOV-2012 Sheet Number  
 Drawn By NIBS  
 Checked By NIBS  
 Project Number  
 Classification UNCLASSIFIED

**Barracks P601**


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3 ROOF FRAMING PLAN  
S111 1:100

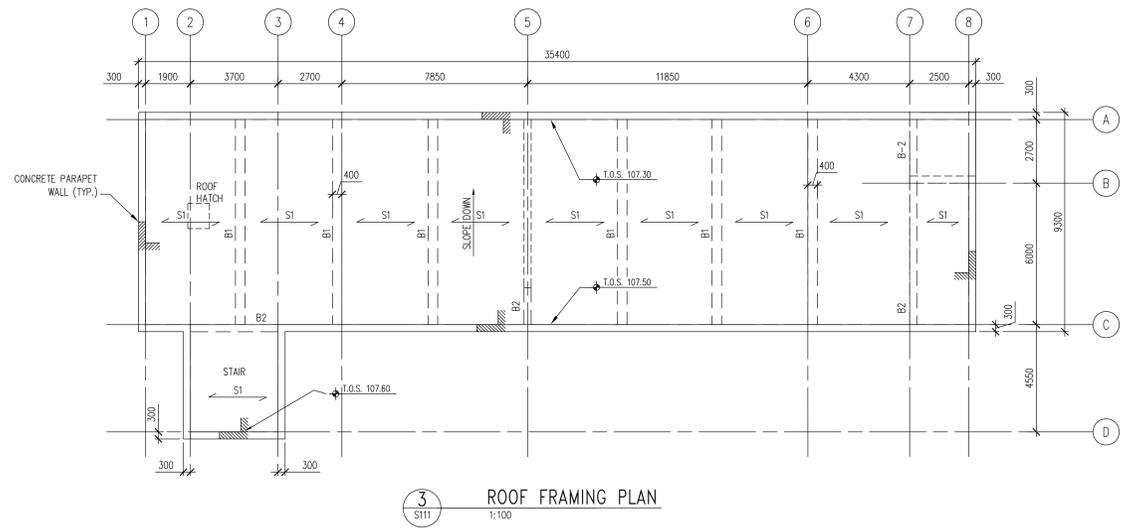

2 LEVEL TWO FRAMING PLAN  
S111 1:100

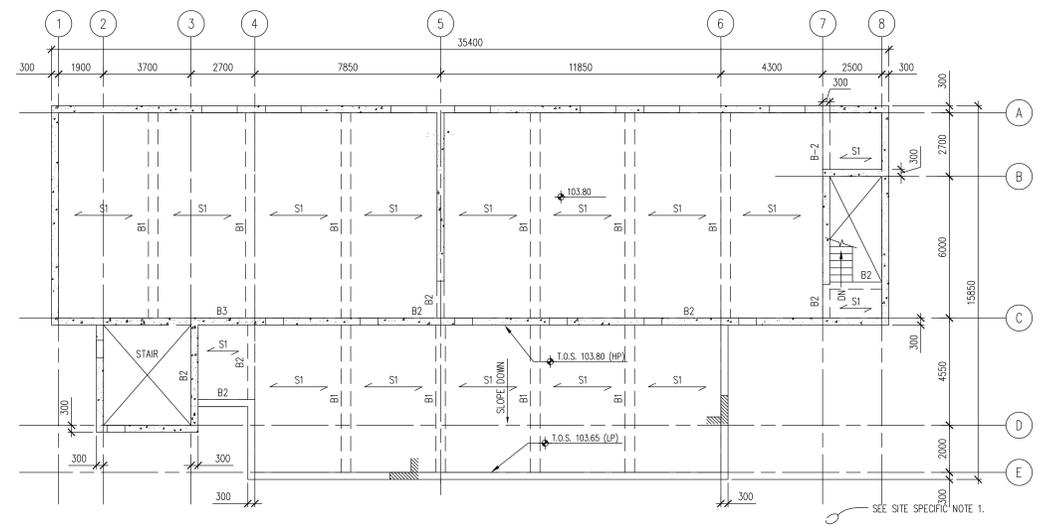

1 LEVEL ONE FOUNDATION PLAN  
S111 1:100

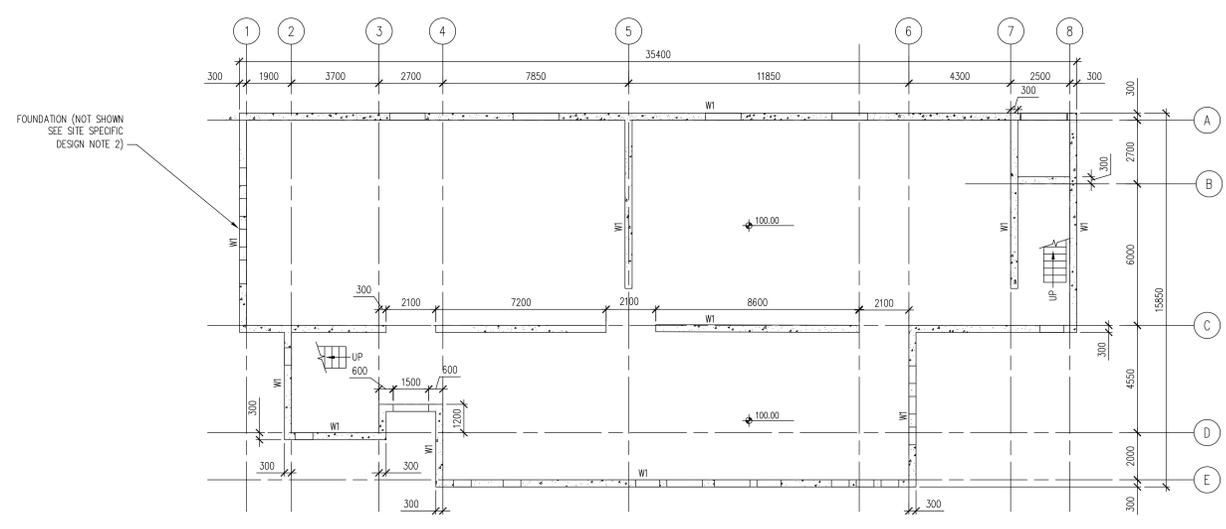PLAN NOTES:

- SEE PLAN FOR TOP OF SLAB.
- FLOOR CONSTRUCTION TO BE 200 mm ONE-WAY CONCRETE SLAB AND BEAMS UNLESS NOTED OTHERWISE.
- $\angle SX$  INDICATES ONE-WAY SLAB TYPE. SEE DWG GEN S631 FOR THICKNESS AND REINFORCING.
- SEE DWG GEN S641 FOR BEAM SCHEDULE.
- PENETRATIONS OR SLEEVES THROUGH STRUCTURAL BEAMS ARE NOT PERMITTED UNLESS SHOWN ON STRUCTURAL DRAWINGS.
- CENTER ALL BEAMS ON GRIDLINES, UNO.
- COORDINATE SIZE AND LOCATION OF ALL OPENINGS, SLEEVES, FLOOR DEPRESSIONS, DRAINS, SLOPES, CURBS, LEDGES, EMBEDS, INSERTS, PADS, ETC WITH ARCH AND MEP DRAWINGS.
- ROOF SLOPE ACHIEVED BY SLOPING TOP & BOT ONE WAY. SEE PLAN FOR TOP OF SLAB (T.O.S.). SEE ARCHT DWGS FOR ADD'L INFO. FOR ACHIEVING SLOPE TO DRAINS.

PLAN NOTES:

- TOP OF SLAB TO BE AT ELEVATION 103.80 UNLESS NOTED OTHERWISE.
- FLOOR CONSTRUCTION TO BE 200 mm ONE-WAY CONCRETE SLAB AND BEAMS UNLESS NOTED OTHERWISE.
- $\angle SX$  INDICATES ONE-WAY SLAB TYPE. SEE DWG GEN S631 FOR THICKNESS AND REINFORCING.
- SEE DWG GEN S641 FOR BEAM SCHEDULE.
- $W_{...}$  INDICATES WALL TYPE. SEE DWG GEN S611 FOR WALL SCHEDULE.
- PENETRATIONS OR SLEEVES THROUGH STRUCTURAL BEAMS ARE NOT PERMITTED UNLESS SHOWN ON STRUCTURAL DRAWINGS.
- CENTER ALL BEAMS ON GRIDLINES, UNO.
- COORDINATE SIZE AND LOCATION OF ALL OPENINGS, SLEEVES, FLOOR DEPRESSIONS, DRAINS, SLOPES, CURBS, LEDGES, EMBEDS, INSERTS, PADS, ETC WITH ARCH AND MEP DRAWINGS.
- ROOF SLOPE ACHIEVED BY SLOPING TOP & BOT ONE WAY. SEE PLAN FOR TOP OF SLAB (T.O.S.). SEE ARCHT DWGS FOR ADD'L INFO. FOR ACHIEVING SLOPE TO DRAINS.

PLAN NOTES:

- TOP OF CONCRETE SLAB-ON-GRADE TO BE AT ELEVATION 100.00 UNLESS NOTED OTHERWISE.
- SLAB-ON-GRADE TO BE 125 mm THICK REINFORCED WITH #3 @ 400 EACH WAY OVER VAPOR RETARDER OVER MINIMUM 150 mm LAYER OF COMPACTED DRAINAGE FILL MATERIAL, UNO. SEE DWG GEN S501 FOR SOG DETAILS.
- BOTTOM OF WALL FOOTINGS ELEVATIONS TO BE XXXX UNLESS NOTED THUS [XXXX] ON PLAN.
- CENTERLINE OF FOOTINGS SHALL COINCIDE WITH CENTERLINE OF WALLS AND COLUMNS UNLESS NOTED OTHERWISE.
- SEE DWG GEN S601 FOR WALL FOOTING SCHEDULE.
- $W_{...}$  INDICATES WALL TYPE. SEE DWG GEN S611 FOR WALL SCHEDULE.
- COORDINATE SIZE AND LOCATION OF ALL OPENINGS, SLEEVES, FLOOR DEPRESSIONS, DRAINS, SLOPES, CURBS, LEDGES, EMBEDS, INSERTS, PADS, ETC WITH ARCH AND MEP DRAWINGS.
- COORDINATE ALL UNDERGROUND UTILITIES WITH CIVL & ARCH DRAWINGS.

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SITE SPECIFIC DESIGN CRITERIA


- ON PROJECT SPECIFIC DESIGN DRAWINGS PROVIDE OVERALL STRUCTURAL BUILDING DIMENSIONS ON ALL LEVELS.
- FOUNDATION SYSTEM SHALL BE DESIGNED AND CONSTRUCTED IN ACCORDANCE WITH SITE SPECIFIC GEOTECHNICAL CONDITIONS. SEE SECTION C OF THE STATEMENT OF WORK.
- THE SOG INDICATED IS A SITE SPECIFIC MINIMUM. LOCAL CONDITIONS MAY REQUIRE INCREASED THICKNESS AND REINFORCEMENT, OR REQUIRE A FRAMED SLAB.
- 6X6-W2.9XW2.9 WELDED WIRE FABRIC OR EQUIVALENT MAY BE UTILIZED AS THE MINIMUM INSTEAD OF THE #3 @ 400 EW INDICATED IN THE SOG.
- THE SLAB AND BEAM SIZES INDICATED SHALL BE CONSIDERED SITE SPECIFIC MINIMUMS.
- ONE WAY STRUCTURAL SLAB SLOPE INDICATED FOR ROOF DRAINAGE. OTHER METHODS OR COMBINATION OF METHODS ARE ACCEPTABLE IF APPROVED BY DE/AD, DE/CSE, AND FAC DURING THE DESIGN PHASE.
- ADJUST SITE SPECIFIC PLAN NOTES AS REQUIRED.
- W1 WALL SHOWN ON GRID LINE 5 IS REQUIRED ON SITE SPECIFIC DRAWINGS IN SEISMIC DESIGN CATEGORIES D, E, AND F.

Rev Number	Description	Date
Revisions		

Release For Construction: NIBS/Asa

FRAMING PLANS

DBO Project Number	Drawing Scale	Phase
CBMS111.DWG	1:100	SCM
CAO Plot Scale	CAO Plot Scale	CAO Plot Scale
Date	NOV-2012	Sheet Number
Drawn By	NIBS	Barracks
Checked By	NIBS	S111
Project Number		
Classification	UNCLASSIFIED	

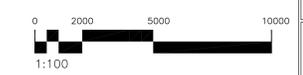


ALL DIMENSIONS WITHOUT A DECIMAL ARE IN MILLIMETERS UNO. ALL DIMENSIONS WITH A DECIMAL ARE IN METERS UNO.


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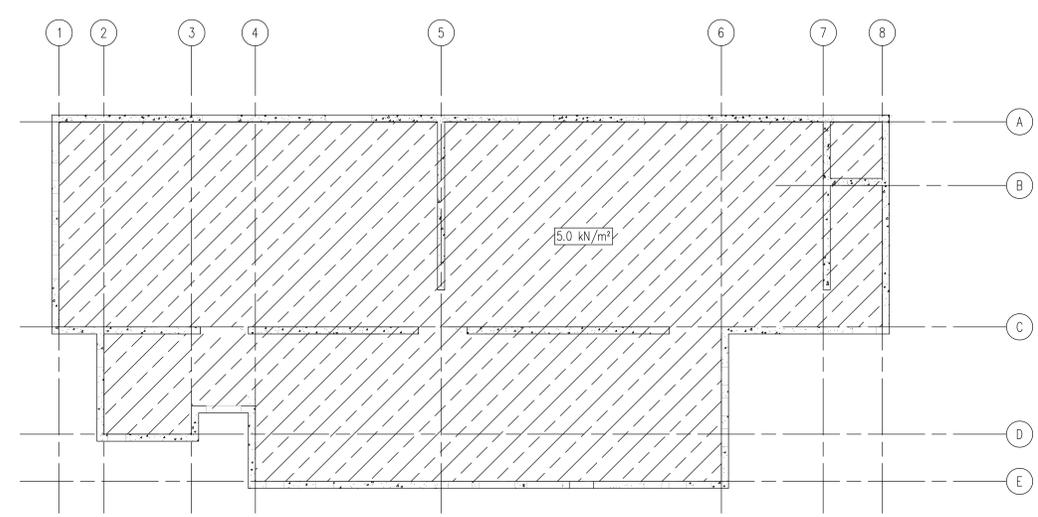
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3 ROOF  
S191 1:100



2 LEVEL TWO  
S191 1:100

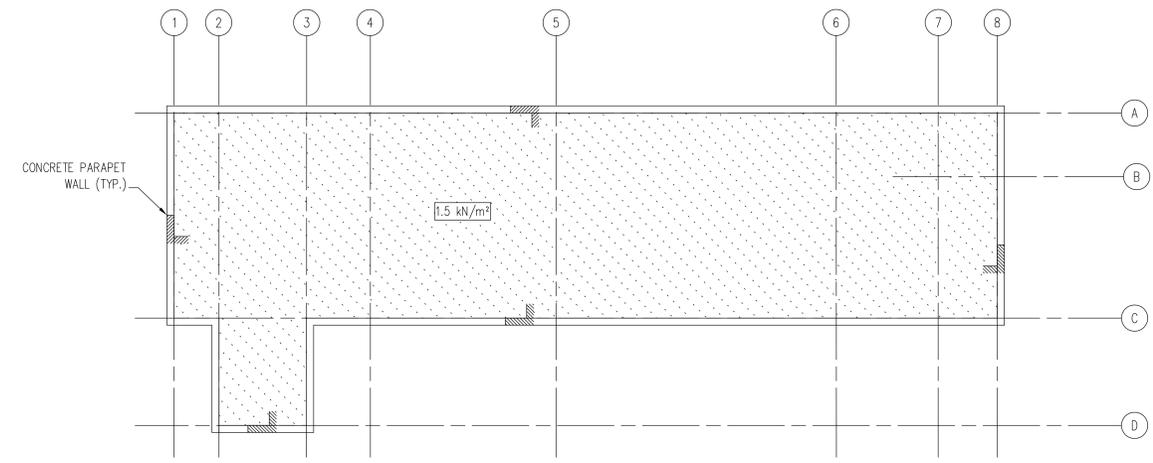

1 LEVEL ONE  
S191 1:100
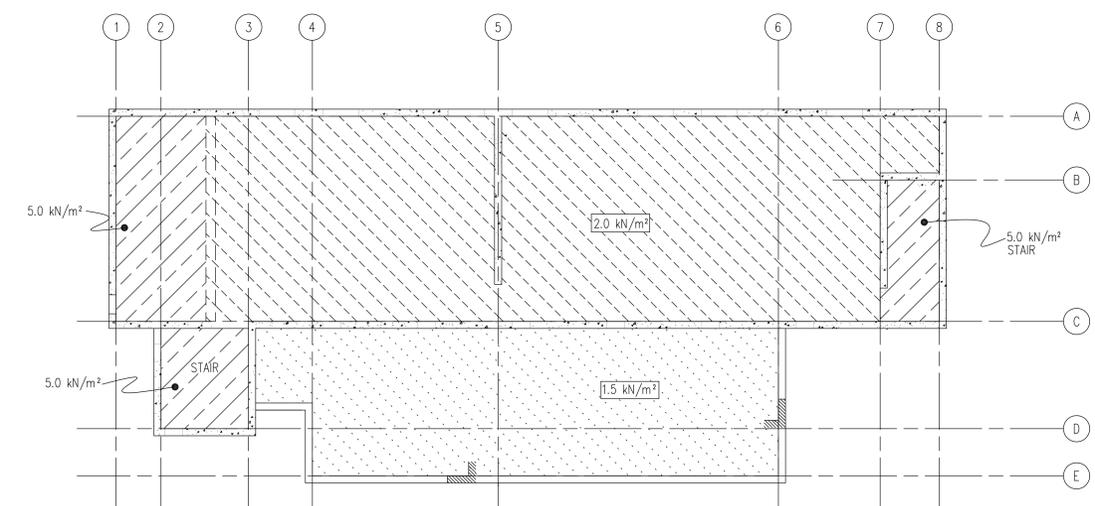
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**LIVE LOAD KEY**  
(INCLUDES 1.0 kN/m<sup>2</sup> PARTITION LOAD WHERE APPLICABLE)


1.5 kN/m <sup>2</sup>	
2.0 kN/m <sup>2</sup>	
5.0 kN/m <sup>2</sup>	

- SITE SPECIFIC DESIGN NOTES.**
- THE LIVE LOAD PATTERNS INDICATED IN THE KEY SHALL BE USED ON PROJECT SPECIFIC DESIGN DRAWINGS.
  - LIVE LOADS SHOWN ARE SCHEMATIC. PROJECT SPECIFIC DESIGN DRAWINGS SHALL REFLECT DETAILED COORDINATION WITH OTHER DISCIPLINES (E.G. ROOM TYPES, EQUIPMENT LOADS, ETC.).

Rev. Number	Description	Date
Revisions		

**LIVE LOAD DIAGRAMS**

DBO Project Number	Drawing Scale	Phase
AS NOTED	1:1	SCHEMATIC
CADD File Name	CADD Plot Scale	DATE
CBMS191.DWG	1:1	NOV-2012
Drawn By	Checked By	Project Number
NIBS	NIBS	Barracks S191
Classification	UNCLASSIFIED	

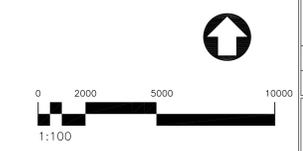

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1 2 3 4 5 6 7 8 9 10 11 12 13 14 15 16 17 18