

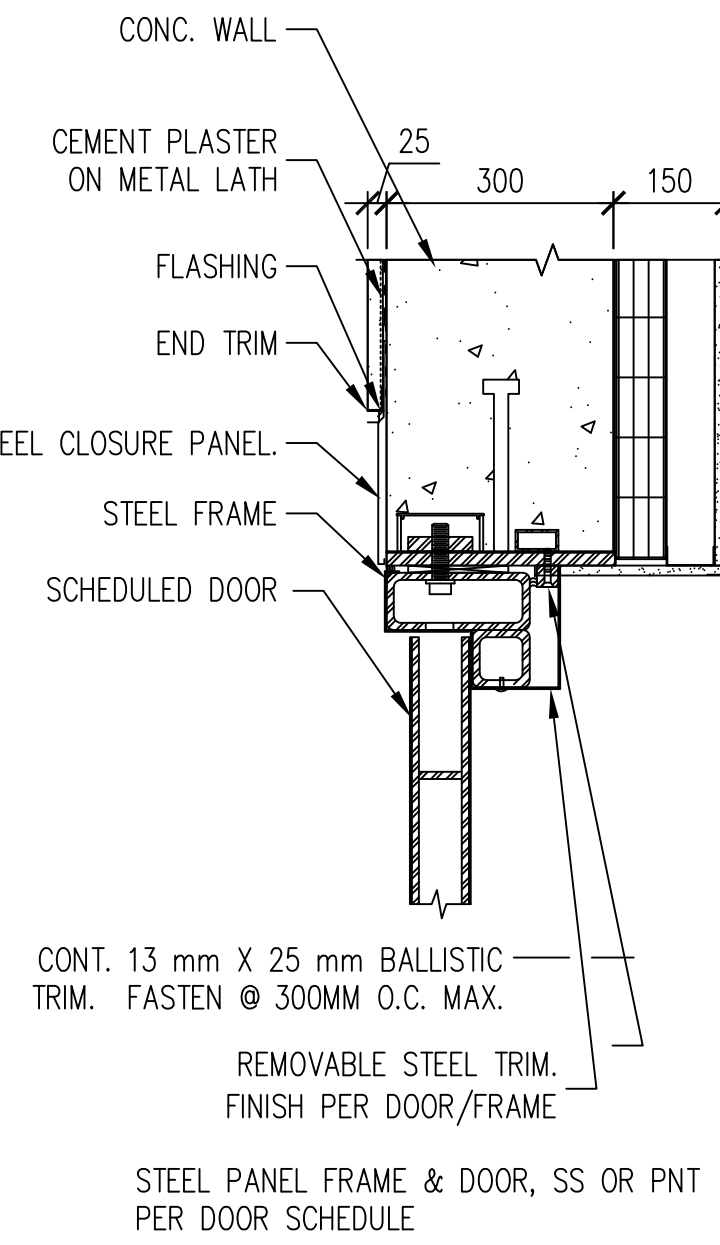
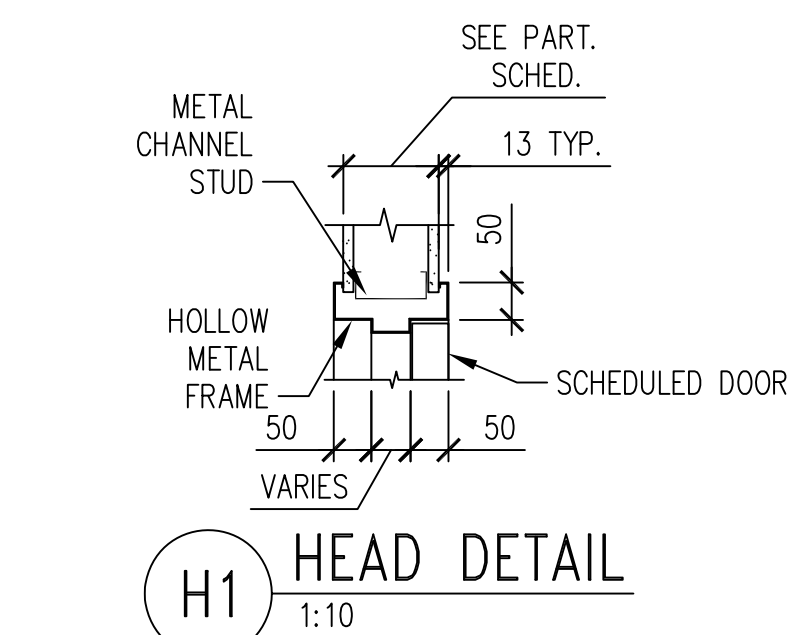


BARRACKS 101 DOOR SCHEDULE










| OPE NUMBER | RM/DOOR NUMBER | DOOR SIZE | | | DOOR TYPE | DOOR MATERIAL | DOOR FINISH | GLAZING TYPE | FEBR CODE | FRAME TYPE | FRAME MATERIAL | FRAME FINISH | FRAME DETAILS | | | FIRE CLASS | LABEL RATING | HARDWARE SET | REMARKS |
|---------------|-------------------|-----------|--------|-----------|--------------|------------------|----------------|-----------------|--------------|---------------|-------------------|-----------------|---------------|------|------|---------------|-----------------|-----------------|---------|
| | | WIDTH | HEIGHT | THICKNESS | | | | | | | | | HEAD | JAMB | SILL | | | | |
| 131-R | 101A | 940 | 2135 | 52 | D1 | STEEL | SS | - | 2123 | F1 | STEEL | SS | H-3 | J-2 | S-14 | - | - | SHW-25A | |
| | 101B | 915 | 2135 | 45 | D4 | WD | PF | - | - | F1 | HM | PNT | H-1 | J-1 | S-21 | - | - | 110 | |
| | 102 | 915 | 2135 | 45 | D1 | WD | PF | - | - | F1 | HM | PNT | H-1 | J-1 | S-21 | - | - | 111 | |
| | 103 | 915 | 2135 | 45 | D1 | WD | PF | - | - | F1 | HM | PNT | H-1 | J-1 | S-21 | - | - | 111 | |
| | 104 | 915 | 2135 | 45 | D1 | WD | PF | - | - | F1 | HM | PNT | H-1 | J-1 | S-21 | - | - | 116 | |
| 121-R | 105 | PR 915 | 2135 | 52 | D2 | STEEL | SS | - | 2333 | F2 | STEEL | SS | H-3 | J-2 | S-14 | - | - | SHW-19A | |
| | 106 | 762 | 2135 | 45 | D1 | WD | PF | - | - | F1 | HM | PNT | H-1 | J-1 | S-4 | - | - | 111 | |
| | 107 | 762 | 2135 | 45 | D1 | WD | PF | - | - | F1 | HM | PNT | H-1 | J-1 | S-21 | - | - | 110 | |
| | 108 | 915 | 2135 | 45 | D1 | WD | PF | - | - | F1 | HM | PNT | H-1 | J-1 | S-4 | - | - | 140 | |
| | 109 | 915 | 2135 | 45 | D1 | WD | PF | - | - | F1 | HM | PNT | H-1 | J-1 | S-21 | - | - | 116 | |
| | 110 | 915 | 2135 | 45 | D1 | WD | PF | - | - | F1 | HM | PNT | H-1 | J-1 | S-21 | - | - | 110 | |
| | 111 | 915 | 2135 | 45 | D1 | WD | PF | - | - | F1 | HM | PNT | H-1 | J-1 | S-21 | - | - | 116 | |
| | 112 | 915 | 2135 | 45 | D1 | WD | PF | - | - | F1 | HM | PNT | H-1 | J-1 | S-21 | - | - | 140 | |
| | 113 | 915 | 2135 | 45 | D1 | WD | PF | - | - | F1 | HM | PNT | H-1 | J-1 | S-9 | - | - | 116 | |
| 121-R | 115 | PR 915 | 2135 | 52 | D2 | STEEL | SS | - | 2333 | F2 | STEEL | SS | H-3 | J-2 | S-14 | - | - | SHW-19A | |
| 131-R | 116A | 940 | 2135 | 52 | D1 | STEEL | SS | - | 2123 | F1 | STEEL | SS | H-3 | J-2 | S-14 | - | - | SHW-25A | |
| | 116B | 915 | 2135 | 45 | D1 | WD | PF | - | - | F1 | HM | PNT | H-1 | J-1 | S-21 | - | - | 106 | |
| 131-L | 118A | 940 | 2135 | 52 | D1 | STEEL | SS | - | 2123 | F1 | STEEL | SS | H-3 | J-2 | S-14 | - | - | SHW-25A | |
| | 118B | 940 | 2135 | 52 | D1 | STEEL | SS | - | 2123 | F1 | STEEL | SS | H-3 | J-2 | S-14 | - | - | SHW-25A | |
| | 119 | 915 | 2135 | 45 | D1 | WD | PF | - | - | F1 | HM | PNT | H-1 | J-1 | S-9 | - | - | 110 | |
| | 120 | 915 | 2135 | 45 | D1 | WD | PF | - | - | F1 | HM | PNT | H-1 | J-1 | S-21 | - | - | 116 | |
| | 121 | 915 | 2135 | 45 | D4 | WD | PF | K | - | F1 | HM | PNT | H-1 | J-1 | S-21 | - | - | 110 | |
| | 122 | 915 | 2135 | 45 | D1 | WD | PF | - | - | F1 | HM | PNT | H-1 | J-1 | S-9 | - | - | 110 | |
| 132-R | 123 | 940 | 2135 | 52 | D6 | STEEL | SS | - | 1123 | F1 | STEEL | SS | H-3 | J-2 | S-14 | - | - | SHW-25 | |
| | 124 | 915 | 2135 | 45 | D1 | WD | PF | - | - | F1 | HM | PNT | H-1 | J-1 | S-21 | - | - | 110 | |
| | | | | | | | | | | | | | | | | | | | |
| LEVEL TWO | | | | | | | | | | | | | | | | | | | |
| | 201 | 915 | 2135 | 45 | D1 | WD | PF | - | - | F1 | HM | PNT | H-1 | J-1 | S-5 | - | - | 116A | |
| | 202 | 915 | 2135 | 45 | D1 | WD | PF | - | - | F1 | HM | PNT | H-1 | J-1 | S-5 | - | - | SHW-14 | |
| | 203 | 915 | 2135 | 45 | D1 | WD | PF | - | - | F1 | HM | PNT | H-1 | J-1 | S-9 | - | - | 116A | |
| | 203A | 610 | 2135 | 45 | D1 | WD | PF | - | - | F1 | HM | PNT | H-1 | J-1 | S-9 | - | - | 110 | |
| | 203B | PR 762 | 2135 | 45 | D1 | WD | PF | - | - | F2 | HM | PNT | H-1 | J-1 | S-9 | - | - | 123 | |
| | 204 | 762 | 2135 | 45 | D1 | WD | PF | - | - | F1 | HM | PNT | H-1 | J-1 | S-4 | - | - | 111 | |
| | 205 | 915 | 2135 | 45 | D1 | WD | PF | - | - | F1 | HM | PNT | H-1 | J-1 | S-9 | - | - | 116A | |
| | 205A | 610 | 2135 | 45 | D1 | WD | PF | - | - | F1 | HM | PNT | H-1 | J-1 | S-9 | - | - | 110 | |
| | 205B | PR 762 | 2135 | 45 | D1 | WD | PF | - | - | F2 | HM | PNT | H-1 | J-1 | S-9 | - | - | 123 | |
| | 206 | 762 | 2135 | 45 | D1 | WD | PF | - | - | F1 | HM | PNT | H-1 | J-1 | S-4 | - | - | 111 | |
| | 207 | 915 | 2135 | 45 | D1 | WD | PF | - | - | F1 | HM | PNT | H-1 | J-1 | S-9 | - | - | 116A | |
| | 207A | 610 | 2135 | 45 | D1 | WD | PF | - | - | F1 | HM | PNT | H-1 | J-1 | S-9 | - | - | 110 | |
| | 207B | PR 762 | 2135 | 45 | D1 | WD | PF | - | - | F2 | HM | PNT | H-1 | J-1 | S-9 | - | - | 123 | |
| | 208 | 762 | 2135 | 45 | D1 | WD | PF | - | - | F1 | HM | PNT | H-1 | J-1 | S-4 | - | - | 111 | |
| | 209 | 915 | 2135 | 45 | D1 | WD | PF | - | - | F1 | HM | PNT | H-1 | J-1 | S-9 | - | - | 116A | |
| | 209A | 610 | 2135 | 45 | D1 | WD | PF | - | - | F1 | HM | PNT | H-1 | J-1 | S-9 | - | - | 110 | |
| | 209B | PR 762 | 2135 | 45 | D1 | WD | PF | - | - | F2 | HM | PNT | H-1 | J-1 | S-9 | - | - | 123 | |
| | 210 | 762 | 2135 | 45 | D1 | WD | PF | - | - | F1 | HM | PNT | H-1 | J-1 | S-4 | - | - | 141 | |
| | 211 | 915 | 2135 | 45 | D1 | WD | PF | - | - | F1 | HM | PNT | H-1 | J-1 | S-9 | - | - | 116A | |
| | 211A | 610 | 2135 | 45 | D1 | WD | PF | - | - | F1 | HM | PNT | H-1 | J-1 | S-9 | - | - | 110 | |
| | 211B | PR 762 | 2135 | 45 | D1 | WD | PF | - | - | F2 | HM | PNT | H-1 | J-1 | S-9 | - | - | 123 | |
| | 212 | 762 | 2135 | 45 | D1 | WD | PF | - | - | F1 | HM | PNT | H-1 | J-1 | S-4 | - | - | 111 | |
| | 213 | 915 | 2135 | 45 | D1 | WD | PF | - | - | F1 | HM | PNT | H-1 | J-1 | S-9 | - | - | 116A | |
| | 213A | 610 | 2135 | 45 | D1 | WD | PF | - | - | F1 | HM | PNT | H-1 | J-1 | S-9 | - | - | 110 | |
| | 213B | PR 762 | 2135 | 45 | D1 | WD | PF | - | - | F2 | HM | PNT | H-1 | J-1 | S-9 | - | - | 123 | |
| | 214 | 762 | 2135 | 45 | D1 | WD | PF | - | - | F1 | HM | PNT | H-1 | J-1 | S-4 | - | - | 111 | |
| | 215 | 915 | 2135 | 45 | D1 | WD | PF | - | - | F1 | HM | PNT | H-1 | J-1 | S-9 | - | - | 116A | |
| | 215A | 610 | 2135 | 45 | D1 | WD | PF | - | - | F1 | HM | PNT | H-1 | J-1 | S-9 | - | - | 110 | |
| | 215B | PR 762 | 2135 | 45 | D1 | WD | PF | - | - | F2 | HM | PNT | H-1 | J-1 | S-9 | - | - | 123 | |
| | 216 | 762 | 2135 | 45 | D1 | WD | PF | - | - | F1 | HM | PNT | H-1 | J-1 | S-4 | - | - | 111 | |
| | 217A | 915 | 2135 | 45 | D1 | WD | PF | - | - | F1 | HM | PNT | H-1 | J-1 | S-5 | - | 90 | 106A | |
| | 217B | 915 | 2135 | 45 | D1 | WD | PF | - | - | F1 | HM | PNT | H-1 | J-1 | S-5 | - | 90 | 106A | |
| | | | | | | | | | | | | | | | | | | | |

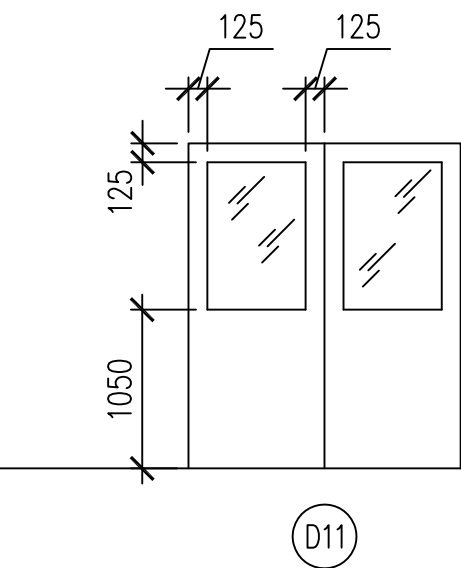

DOOR TYPES SCALE 1:50

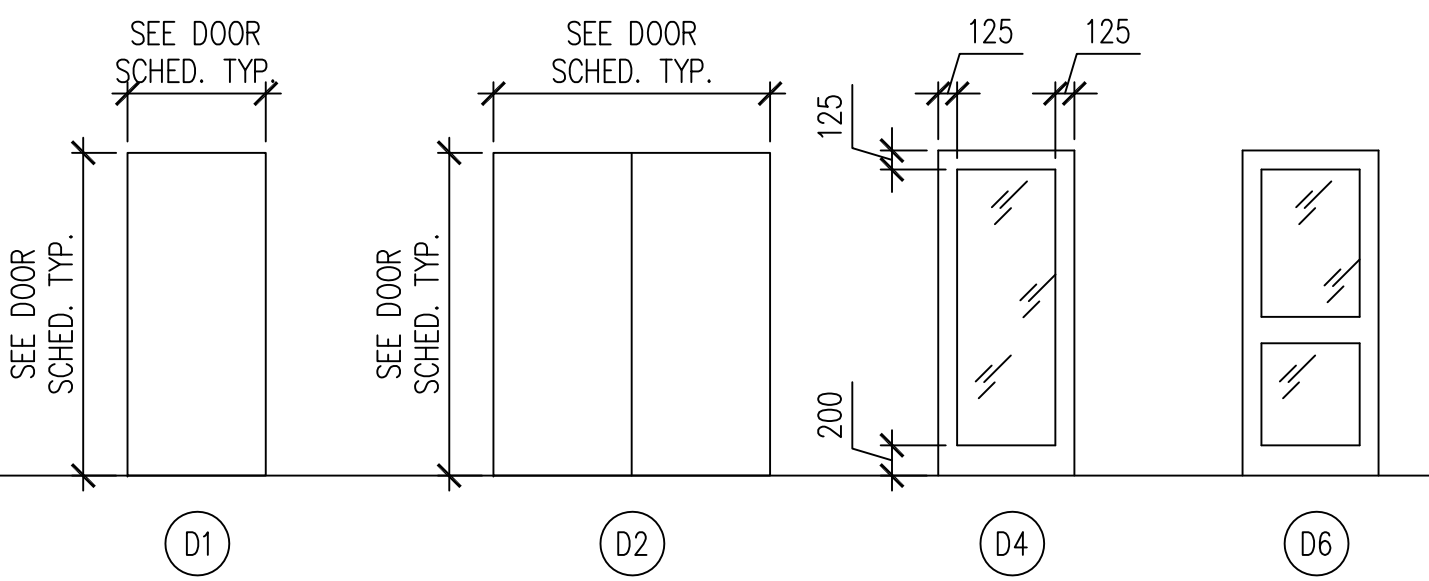

FRAME TYPES SCALE 1:50

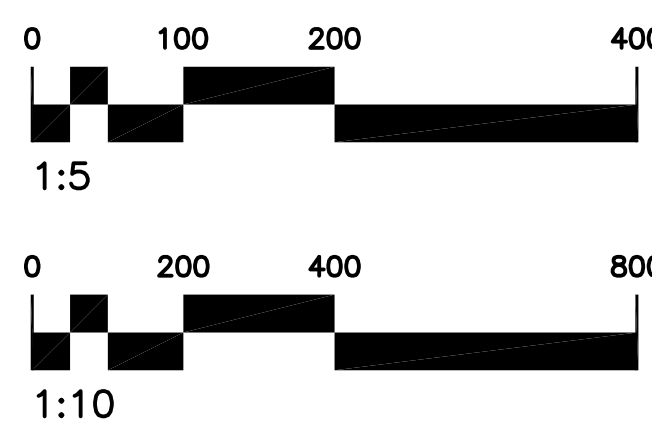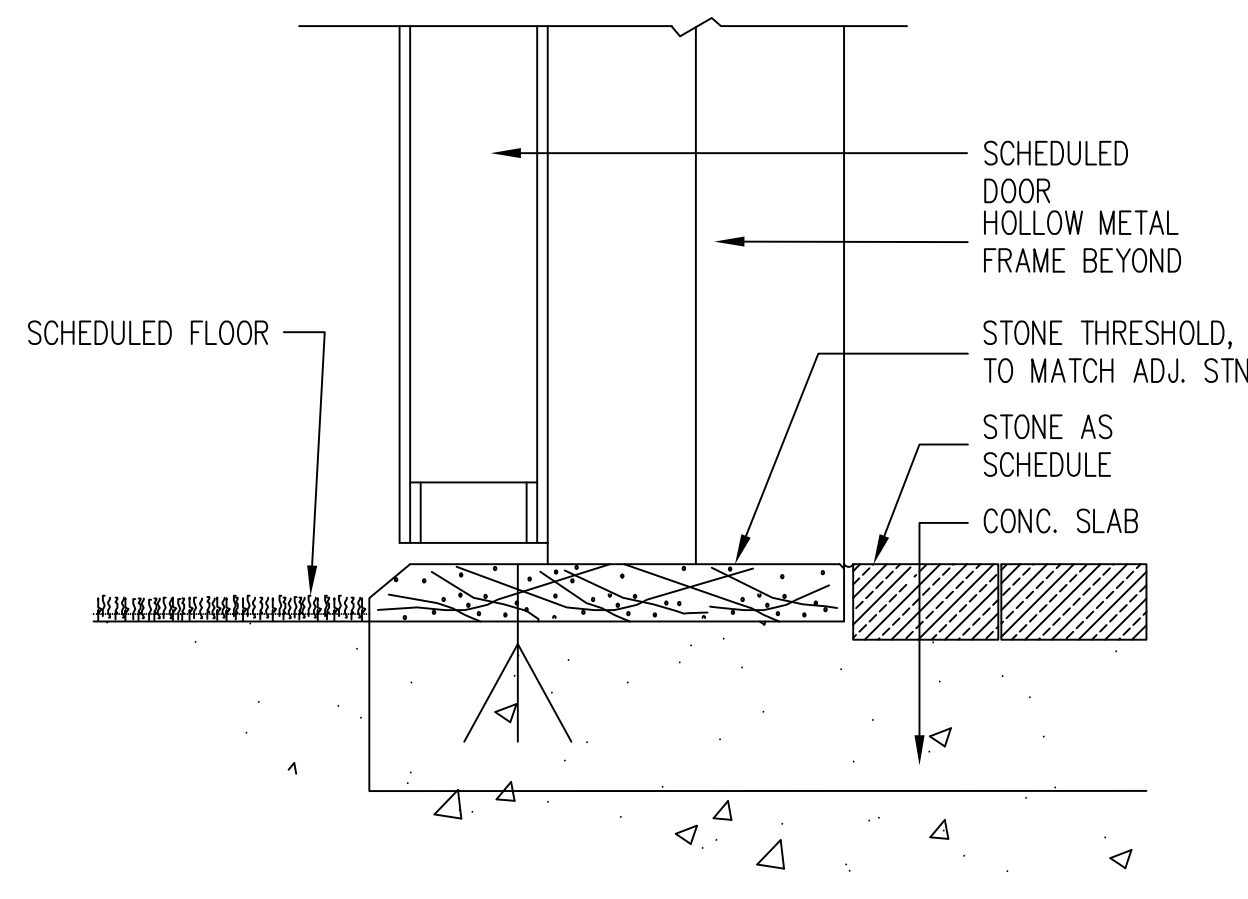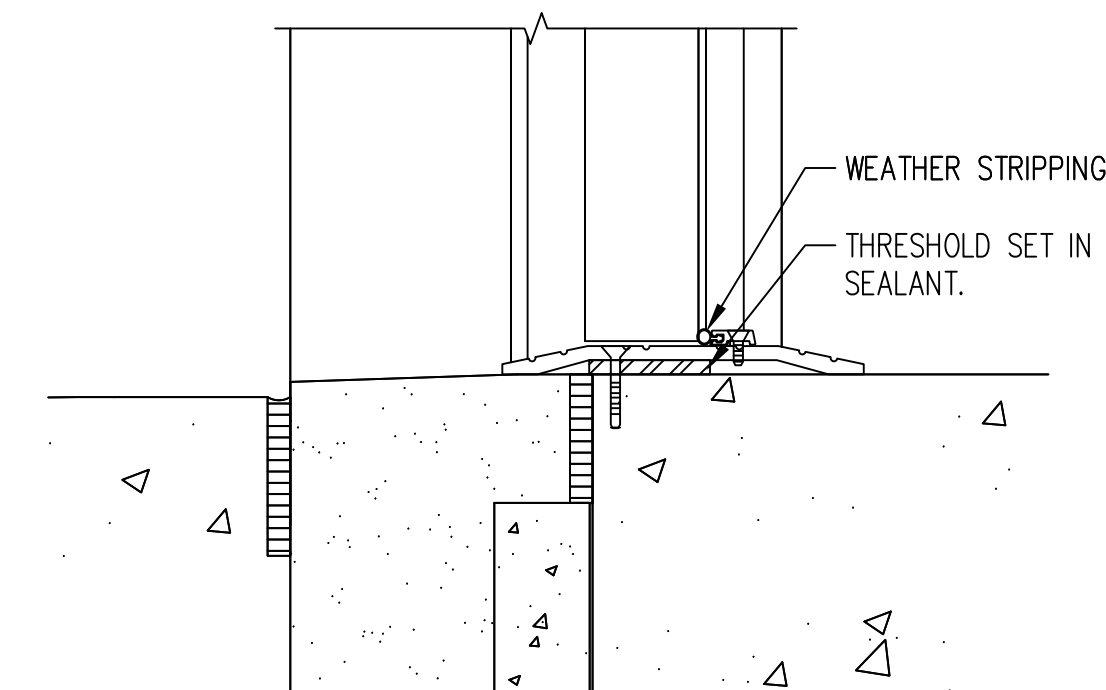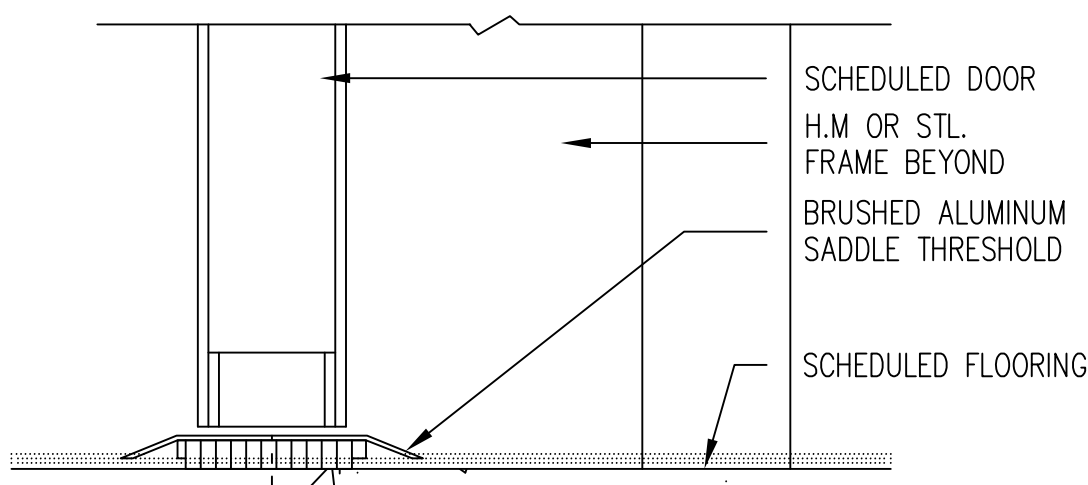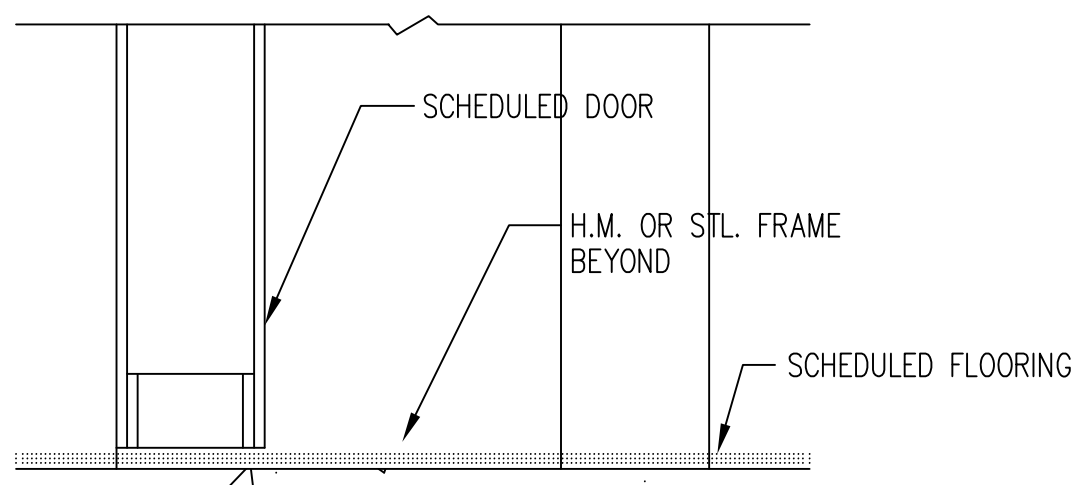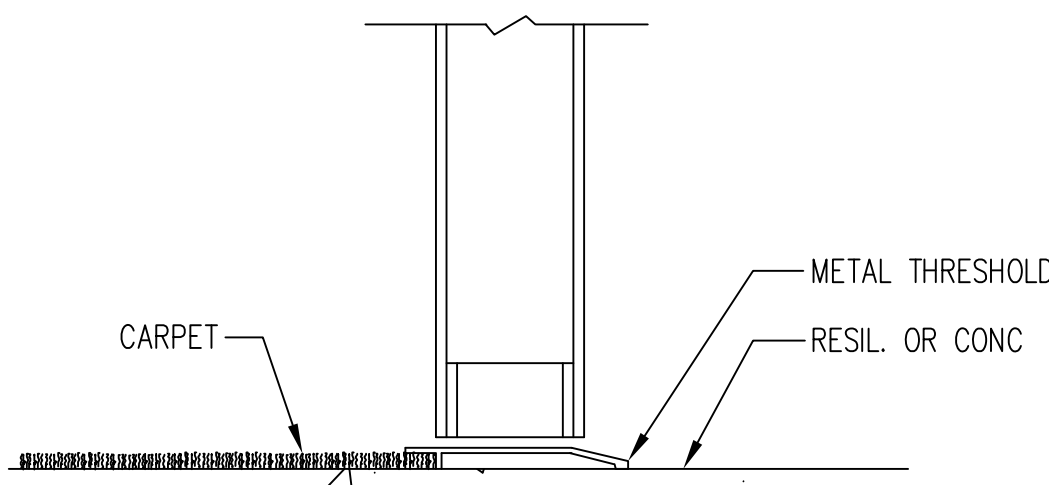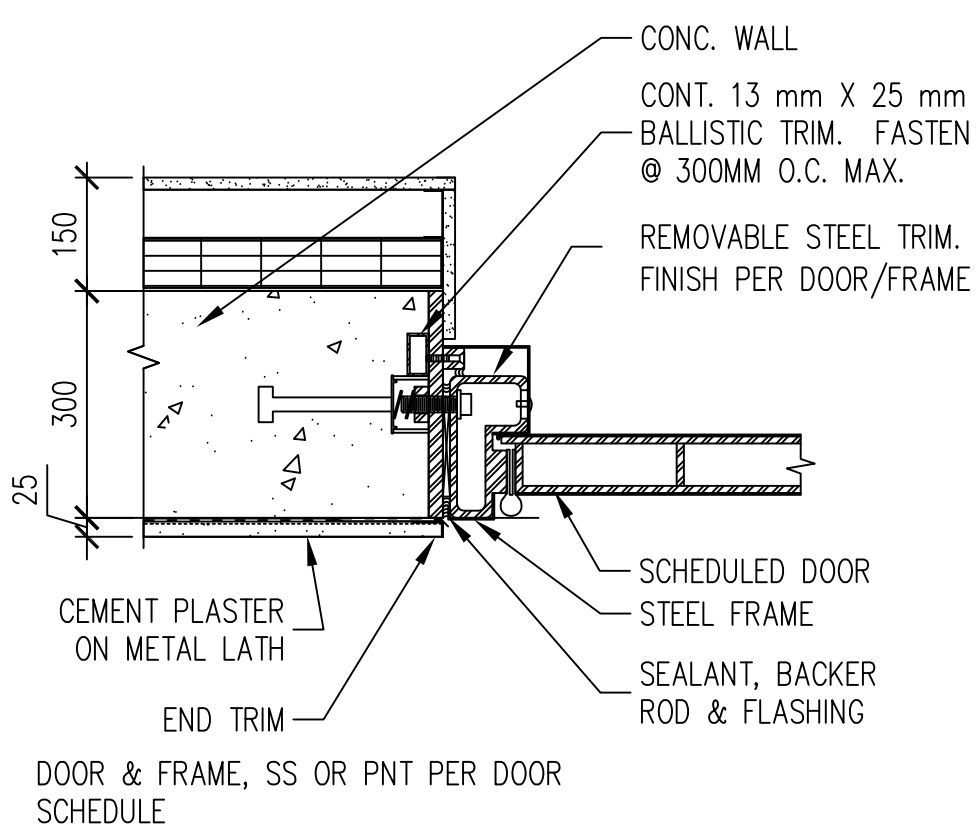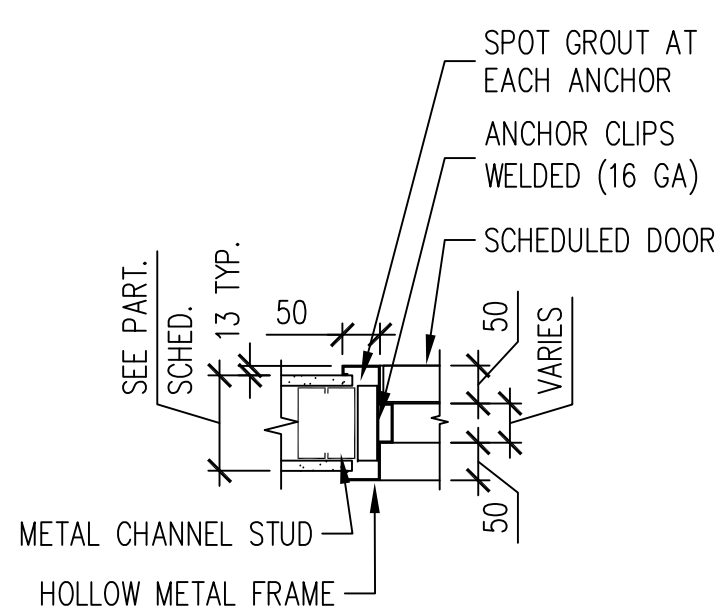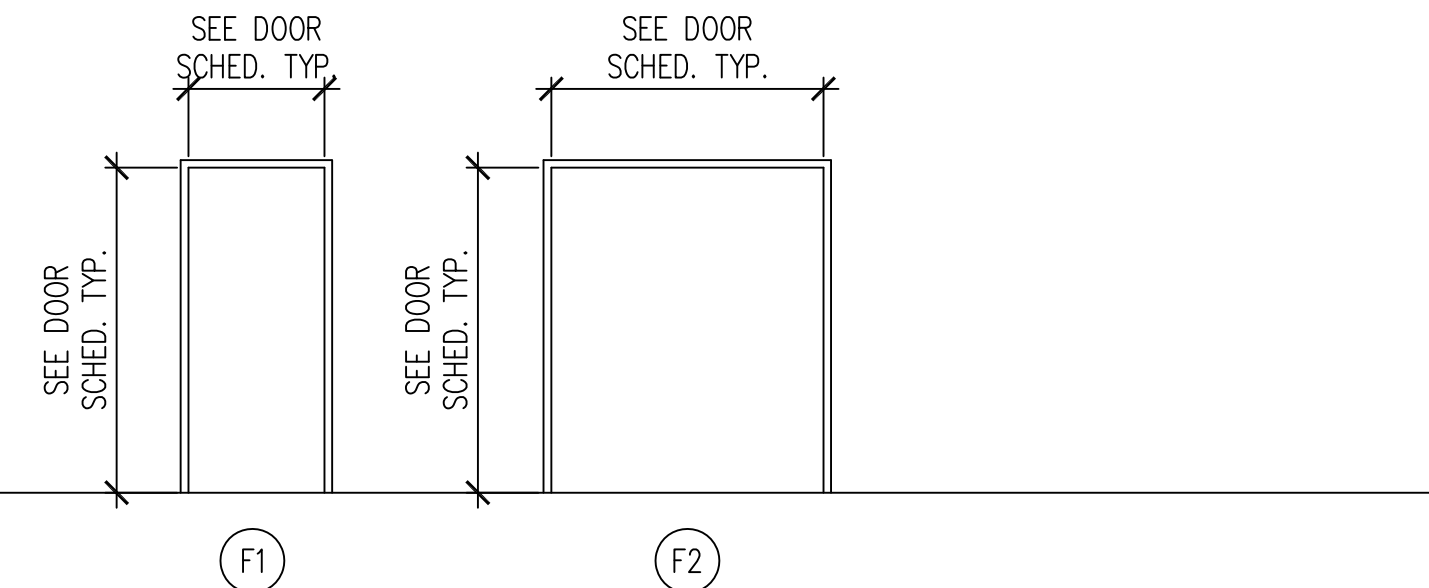

National Institute of Building Sciences
building Smart Alliance
Washington, DC

Barracks 101
Building Information Model
Common File

WARNING: All building models provided by buildingSMART alliance are licensed under a Creative Commons Attribution-NoDerivs 3.0 Unported License.
National Institute of Building Sciences
buildingSMARTalliance
Washington, DC 20005

| Rev. Number | Description | Date |
|-------------|-------------|------|
| Revisions | | |

| | | |
|---------------------------|----------------|--------------|
| Release For Construction: | | |
| NBS/Asa | NBS/Asa | |
| Drawing Title | | |
| DOOR SCHEDULE AND DETAILS | | |
| GEO Project Number | Drawing Scale | Phase |
| AS NOTED | 1:1 | 100% |
| GEO File Name | CAD File Scale | 1:1 |
| CBMAG02.DWG | 1:1 | 1:1 |
| Date | NOV-2012 | Sheet Number |
| Drawn By | NBS | Barracks |
| Checked By | NBS | A602 |
| Project Number | | |
| Classification | UNCLASSIFIED | |